


# PADUCAH MCCRACKEN COUNTY JOINT SEWER AGENCY PADUCAH, KENTUCKY

## GENERATORS AND AUTOMATIC TRANSFER SWITCHES JANUARY 2025 PHASE 1 & PHASE 2

### PADUCAH MCCRACKEN COUNTY JOINT SEWER AGENCY BOARD OF DIRECTORS

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<b>WILL COX</b> .....	<b>BOARD MEMBER</b>
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<b>CAROL YOUNG</b> .....	<b>BOARD MEMBER</b>
<b>JOHN HODGES, P.E., L.S.</b> .....	<b>EXECUTIVE DIRECTOR</b>

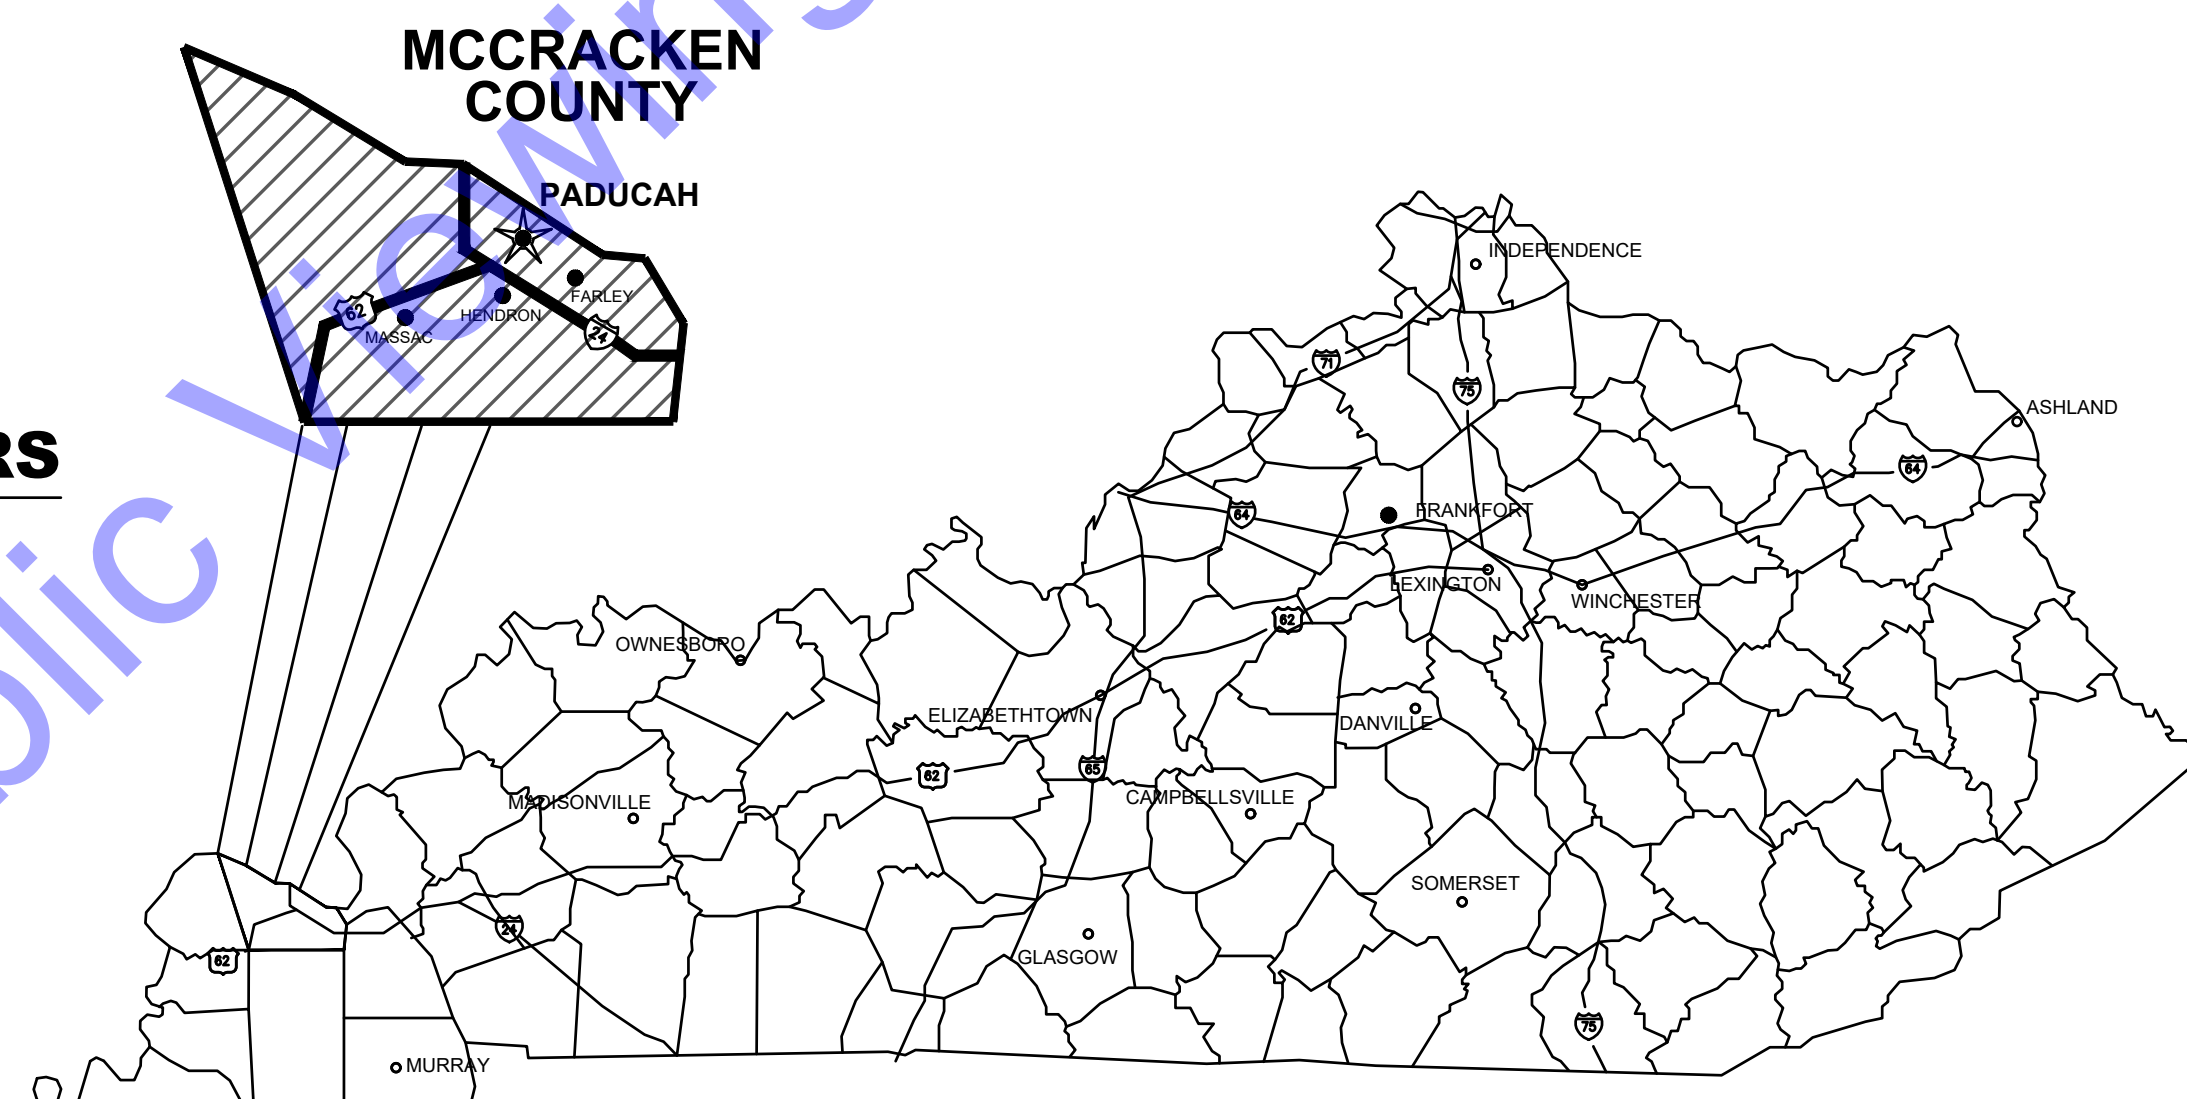


GENERAL LOCATION MAP



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QA/QC BY: *Toby Church* 1/13/2025  
TOBY CHURCH DATE :

CERTIFIED BY: *Mark Nordmeyer* 1/13/2025  
MARK NORDMEYER DATE :  
KENTUCKY P.E. No. 30193

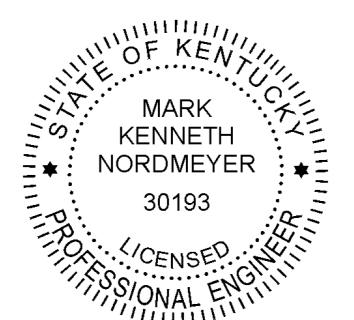


CONTRACT NO. : S24137





VICINITY MAP  
 SCALE: 1"=4000'-0"

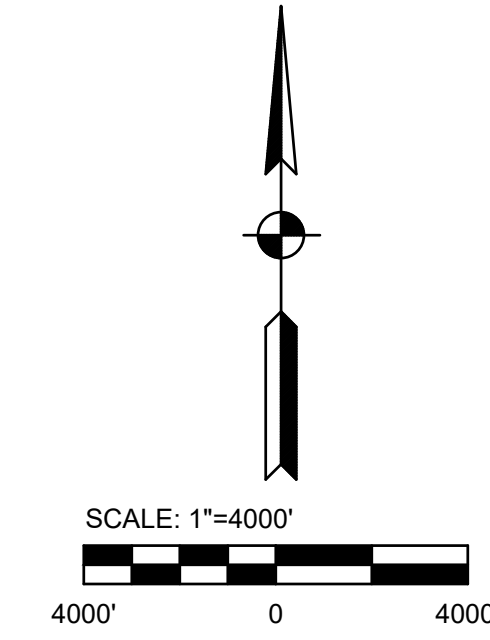

INDEX TO SHEETS		
SHEET #	DRAWING #	DESCRIPTION
1	G1	TITLE SHEET
2	G2	VICINITY MAP AND INDEX TO SHEETS (PHASE 1 & PHASE 2)
3	E0-0	ELECTRICAL LEGENDS AND SCHEDULES (PHASE 1 & PHASE 2)
4	E1-0	ELECTRICAL- REIDLAND WWTP DEMOLITION AND RELOCATION (PHASE 1)
5	E1-1	ELECTRICAL- DOWNS ROAD LIFT STATION (PHASE 1)
6	E1-2	ELECTRICAL - DOWNS ROAD LIFT STATION RISER DIAGRAM (PHASE 1)
7	E1-3	ELECTRICAL- DOWNS ROAD LIFT STATION ONE-LINE DIAGRAM (PHASE 1)
8	E2-0	ELECTRICAL- HAPPY HOLLOW LIFT STATION SITE PLAN (PHASE 2)
9	E2-1	ELECTRICAL- HAPPY HOLLOW LIFT STATION RISER DIAGRAM (PHASE 2)
10	E2-2	ELECTRICAL- HAPPY HOLLOW LIFT STATION ONE-LINE DIAGRAM (PHASE 2)
11	E3-0	ELECTRICAL- MILTON LIFT STATION SITE PLAN AND ONE-LINE DIAGRAM (PHASE 2)
12	E3-1	ELECTRICAL- MILTON LIFT STATION RISER DIAGRAM (PHASE 2)

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STATE OF KENTUCKY  
 MARK KENNETH NORDMEYER  
 30193  
 LICENSED PROFESSIONAL ENGINEER

*Mark Nordmeyer*  
 Signature  
 1/13/2025  
 Date

**PADUCAH MCCRACKEN COUNTY  
 JOINT SEWER AGENCY  
 PADUCAH, KENTUCKY**

**GENERATORS AND AUTOMATIC  
 TRANSFER SWITCHES  
 JANUARY 2025  
 PHASE 1 & PHASE 2**

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Designed By: JTS	Drawn By: JTS	Checked By: TLC
Issue Date: 01/2025	Project No: S24137	Scale: AS SHOWN

VICINITY MAP AND INDEX TO SHEETS (PHASE 1 & PHASE 2)




PROCESS AND INSTRUMENTATION DIAGRAM LEGEND

TAG FUNCTION ABBREVIATIONS

Table of TAG FUNCTION ABBREVIATIONS including ALT, CM, DIFF, DO, F, F(X), FSR, HOA, HORL, IP, LL, LOE, LOS, LR, MA, MOA, O, OCA, OCC, OSC, OR, OOA, ORR, R, SBL, SORT, SS, SSA, SSL, SUM, VIB, FWD, REV, FIR, ESTP, SPD, SUSP, ALRT, RSET, STRT, etc.

INSTRUMENT TAG IDENTIFICATION

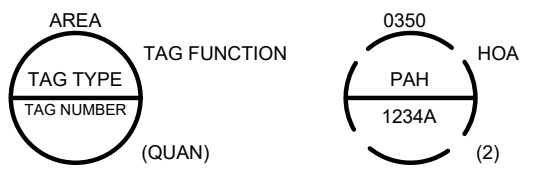


COMPONENT DESIGNATOR


AREA: 0350: BUILDING OR PROCESS AREA NUMBER
TAG TYPE: P: FIRST LETTER, SEE ISA TABLE BELOW
TAG NUMBER: 12: P&ID NUMBER
TAG FUNCTION: HOA: TAG FUNCTION ABBREVIATION, SEE LISTING AT RIGHT

TAG SYMBOLS


HORIZONTAL BAR SYMBOLS FOR PHYSICAL MOUNTING OF DEVICE

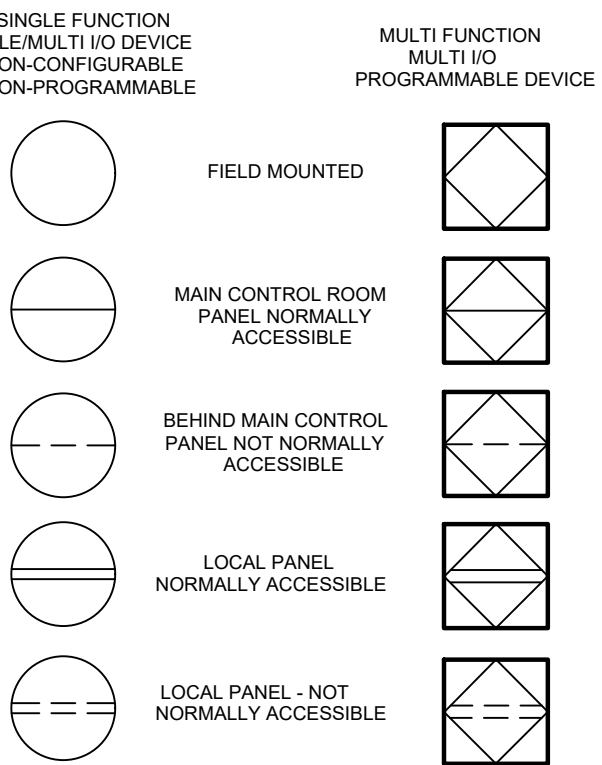

CONTROL AND I/O DEVICES DISPLAY

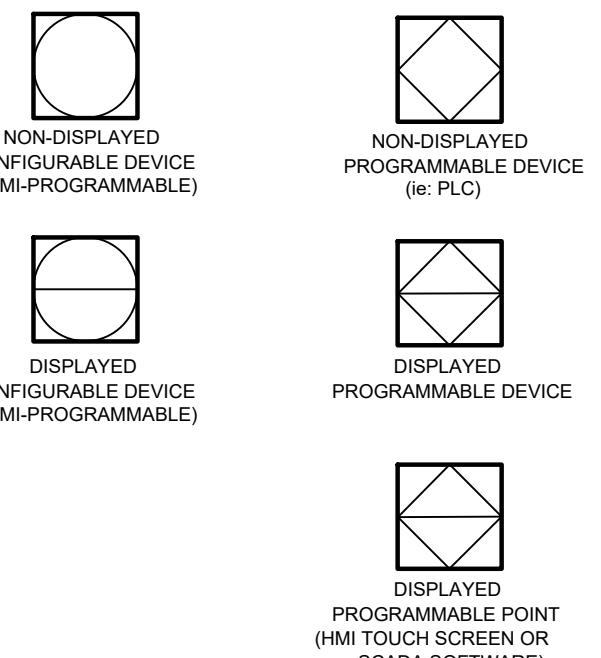

PLC POINT TYPE

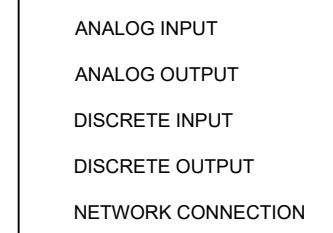

INSTRUMENT SOCIETY OF AMERICA TABLE

Table with columns: LETTER, FIRST LETTER(S), PROCESS OR INITIATING VARIABLE, MODIFIER, READOUT OR PASSIVE FUNCTION, OUTPUT FUNCTION, SUCCEEDING LETTER(S), MODIFIER.

(\*) WHEN USED, EXPLANATION IS SHOWN ADJACENT TO INSTRUMENT SYMBOL

SPECIAL CASES: ETM - ELAPSED TIME METER, JBX - JUNCTION BOX, NDX - INDEX #, MS - MOTOR STARTER, MPR - MOTOR PROTECTION RELAY, MPR - MOTOR PROTECTION RELAY

CONDUIT NOTES

PVC SCHEDULE 40 BELOW GRADE. RIGID ALUMINUM OR PVC COATED RGS CONDUIT ABOVE GRADE OUTDOORS. RIGID ALUMINUM OR PVC COATED RGS CONDUIT IN CLASSIFIED AND CORROSIVE SPACES. NO CONDUIT SHALL BE RUN ON TOP OF A DECK, ON A WALKWAY, OR IN AN AREA THAT MAY POSE A TRIP HAZARD...

CONTROL WIRING REQUIREMENTS

EACH ANALOG INPUT REQUIRES AN 18/2 TWISTED SHIELDED PAIR IN 3/4" CONDUIT UNLESS NOTED OTHERWISE. EACH ANALOG OUTPUT REQUIRES AN 18/2 TWISTED SHIELDED PAIR IN 3/4" CONDUIT UNLESS NOTED OTHERWISE. EACH DISCRETE INPUT REQUIRES 2 #14s IN 3/4" CONDUIT UNLESS NOTED OTHERWISE.

INSTRUMENT POWER

INSTRUMENTS REQUIRING 120 VAC: 1. MAGNETIC FLOW METERS, 2. TURBIDITY TRANSMITTERS, 3. pH TRANSMITTERS, 4. ORP TRANSMITTERS, 5. DO TRANSMITTERS, 6. ULTRASONIC LEVEL TRANSMITTERS, 7. ULTRASONIC FLOW TRANSMITTERS, 8. INFLUENT AND EFFLUENT SAMPLERS.

ELECTRICAL GENERAL NOTES

- (GENERAL NOTES APPLICABLE TO ALL ELECTRICAL SHEETS)
1. CONTRACTOR SHALL EXAMINE NOT ONLY PLANS AND SPECIFICATIONS FOR ELECTRICAL AND INSTRUMENTATION, BUT PLANS AND SPECIFICATIONS FOR OTHER RELATED SECTIONS...
2. THE DRAWINGS ARE DIAGRAMMATIC AND ARE NOT INTENDED TO INCLUDE EVERY DETAIL OF REQUIRED CONSTRUCTION, EQUIPMENT, AND MATERIALS...
3. WHEN SUBSTITUTING OTHER EQUIPMENT, MATERIALS, AND PRODUCTS THAN SPECIFIED IN THE CONTRACT DOCUMENTS, INCLUDE IN PRICING ALL COSTS FOR OTHER DESIGN CHANGES TO THE PROJECT...
4. REVIEW THE CONTRACT DOCUMENTS OF OTHER DIVISIONS, AND COORDINATE ELECTRICAL AND CONTROL WORK WITH THE WORK OF OTHER DISCIPLINES TO AVOID CONFLICTS AND INTERFERENCE.

LEGEND

Table with columns: SYMBOL, DESCRIPTION, MTG HGT AFF TO CL, UOIN. Includes symbols for lighting fixtures, switches, receptacles, and control devices.

LEGEND

Table with columns: ABBREVIATIONS, I, G, ISOLATED GROUND. Lists abbreviations for various electrical components like AVF, ACLG, BEC, C, CL, CLG, COF, COP, CTR, ECB, EMER, EWC, EWH, FAX, FBO, GFI, HGT, FPMR.

Table with columns: SYMBOL, DESCRIPTION, MTG HGT AFF TO CL, UOIN. Lists symbols for raceways, conduits, and other installation details.

ABBREVIATIONS

Table with columns: ABBREVIATION, MEANING. Lists abbreviations like GFI, WP, AFF, UNO, FPMR, IG, M, TSP.

MOTOR CONTROLLER LEGEND

Table with columns: SYMBOL, DESCRIPTION. Lists symbols for motor controller components like MS, SS, VFD, MS, SS, VFD.

LIGHTING LEGEND

Table with columns: SYMBOL, DESCRIPTION. Lists symbols for lighting fixtures like standard ballast and emergency ballast.

PUMP AND METER LEGEND

Table with columns: SYMBOL, DESCRIPTION. Lists symbols for pumps and meters like magnetic flow meter, sonic flow meter, centrifugal pump, lobe pump, peristaltic pump.

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STATE OF KENTUCKY PROFESSIONAL ENGINEER MARK KENNETH NORDMEYER 30193

Signature Date 1/13/2025

PADUCAH MCCracken COUNTY JOINT SEWER AGENCY PADUCAH, KENTUCKY GENERATORS AND AUTOMATIC TRANSFERS SWITCHES JANUARY 2025 PHASE 1 & PHASE 2

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Table for project tracking: Date, Submitted/Revision, No., By, Designated By, Drawn By, Checked By, Issue Date, Project No., Scale.

ELECTRICAL LEGENDS AND SCHEDULES (PHASE 1 & PHASE 2)





A  
1  
2  
7



C  
3  
4

D  
EXISTING 600A  
MANUAL TRANSFER  
SWITCH




F  
5

NEW 600A AUTOMATIC TRANSFER  
SWITCH PRIMARY LOCATION



H

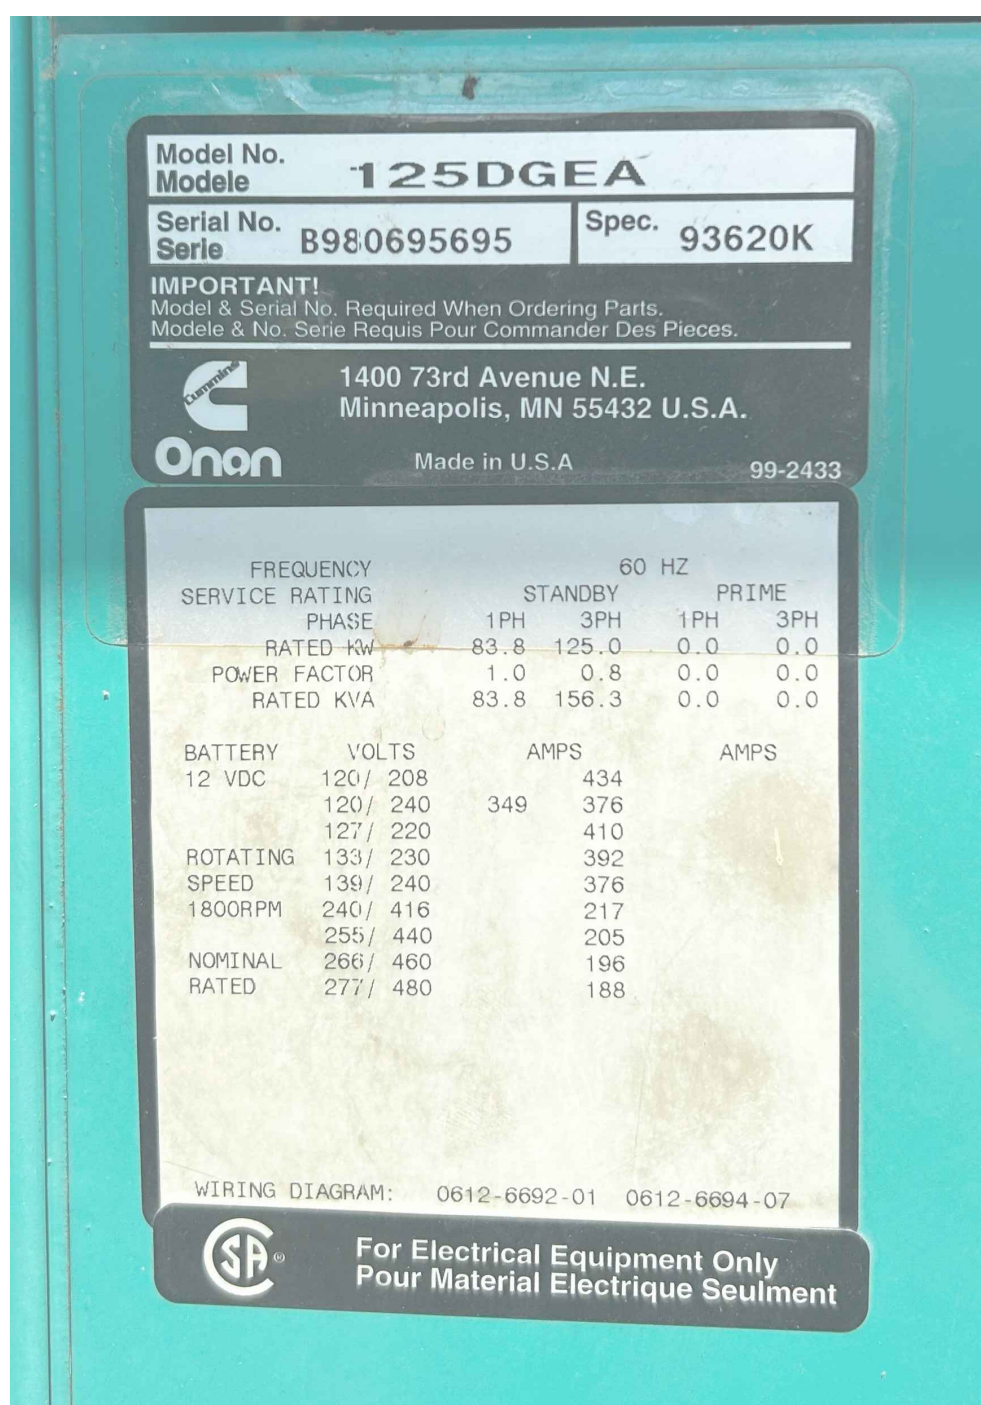

B  
2




E

125KW GENERATOR  
1 2 7

600A MANUAL TRANSFER SWITCH  
3

175KW GENERATOR  
6

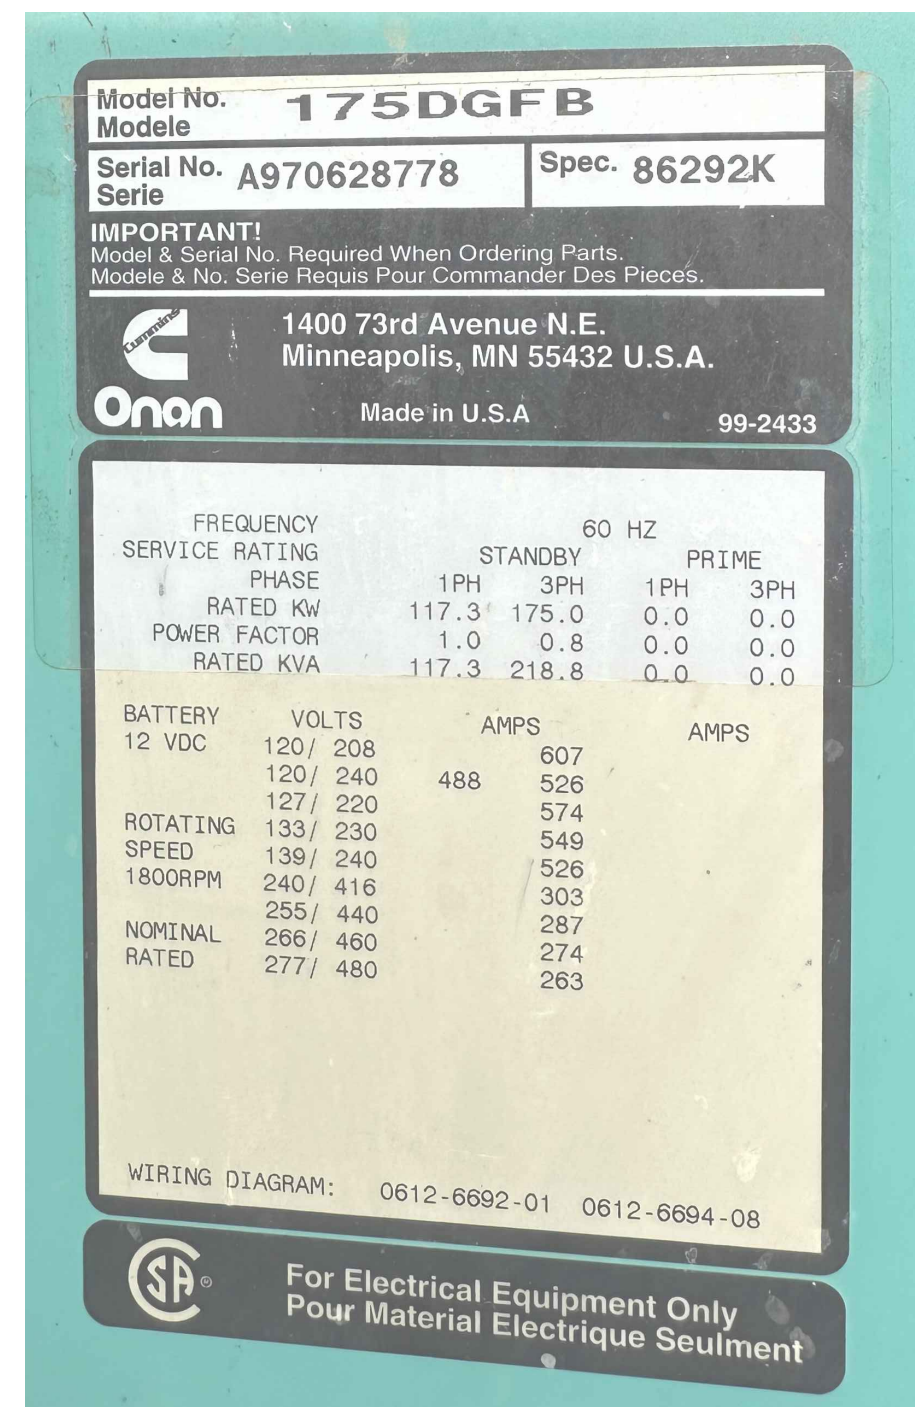

I  
6

**ELECTRICAL RELOCATION AND DEMOLITION NOTES:**

- 1 EXISTING 125KW GENERATOR SHALL BE RELOCATED TO THE DOWNS ROAD LIFT STATION. CONTRACTOR IS RESPONSIBLE FOR ALL COSTS ASSOCIATED WITH THE RELOCATION OF THE GENERATOR.
- 2 CONTRACTOR SHALL COORDINATE WITH ONAN TO ENSURE GENERATOR IS INSTALLED CORRECTLY. CONTRACTOR TO ENSURE THE EXISTING PUMPS LOCATED AT THE DOWNS ROAD LIFT STATION RUN PROPERLY WITH THE GENERATOR INSTALLED.
- 3 THE EXISTING AUTOMATIC TRANSFER SWITCHES FOR THE 125KW GENERATOR AND THE EXISTING MANUAL TRANSFER SWITCH FOR THE 175KW GENERATOR ARE TO BE DEMOLISHED AND REMOVED COMPLETE. EQUIPMENT SHALL BE TURNED OVER TO OWNER.
- 4 CONTRACTOR SHALL PROVIDE AND INSTALL A NEW NEMA 12 JUNCTION BOX TO ALLOW THE EXTENSION OF THE EXISTING WIRES TO ATS. JUNCTION BOX SHALL BE INSTALLED IN PLACE OF EXISTING AUTOMATIC TRANSFER SWITCH AT THE END OF THE EXISTING CONDUIT. ALL EXISTING CONDUIT AND POWER WIRE SHALL BE TERMINATED ON POWER DISTRIBUTION BLOCKS, ILSCO OR EQUAL. WITHIN THE NEW JUNCTION BOX ALL WIRES AND TERMINAL BLOCKS SHALL BE CLEARLY LABELED. CONTRACTOR SHALL PROVIDE ALL MOUNTING HARDWARE AND ANY ASSOCIATED APPURTENANCES REQUIRED FOR PROPER INSTALLATION OF THE NEW JUNCTION BOX.
- 5 EXISTING 600A HEAVY DUTY SAFETY SWITCH IS TO REMAIN.
- 6 THE 175KW GENERATOR SHALL RECEIVE A NEW NEMA 4X, 480V, 3-PHASE, 600A AUTOMATIC TRANSFER SWITCH. NEW NEMA 4X 600A AUTOMATIC TRANSFER SWITCH SHALL BE INSTALLED WHERE THE EXISTING MANUAL TRANSFER SWITCH IS LOCATED. IF NEW 600A AUTOMATIC TRANSFER SWITCH DOES NOT FIT, THE SECONDARY LOCATION IN IMAGE F SHALL BE USED.
- 7 CONTRACTOR IS RESPONSIBLE TO RETAP THE CURRENT 240V 3-PHASE SETUP ON THE 125KW GENERATOR TO CONVERT IT TO 480V 3-PHASE TO MATCH THE DOWNS ROAD LIFT STATION FEED REQUIREMENTS. CONTRACTOR IS RESPONSIBLE FOR ALL COSTS ASSOCIATED WITH THE RETAP.

IMAGE IDENTIFIER LEGEND		
IMAGE	DESCRIPTION	DEMO / RELOCATION NOTES
A	EXISTING 125 KW GENERATOR	TO BE RELOCATED
B	125KW GENERATOR NAMEPLATE	---
C	EXISTING 150A AUTOMATIC TRANSFER SWITCH	TO BE DEMOED
D	EXISTING 600A MANUAL TRANSFER SWITCH	TO BE DEMOED
E	REIDLAND WWTP GENERATORS LAYOUT	---
F	EXISTING 600A SAFETY SWITCH	TO REMAIN
G	NEW 600A AUTOMATIC TRANSFER SWITCH PRIMARY LOCATION	---
H	NEW 600A AUTOMATIC TRANSFER SWITCH SECONDARY LOCATION	---
I	175KW GENERATOR NAMEPLATE	TO REMAIN

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STATE OF KENTUCKY  
MARK KENNETH NORDMEYER  
30193  
LICENSED PROFESSIONAL ENGINEER  
*Mark Nordmeyer*  
Signature Date 1/13/2025

PADUCAH MCCRACKEN COUNTY  
JOINT SEWER AGENCY  
PADUCAH, KENTUCKY  
GENERATORS AND AUTOMATIC  
TRANSFERS SWITCHES  
JANUARY 2025  
PHASE 1 & PHASE 2

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Designed By: JTS	Drawn By: JTS	Checked By: TLC
Issue Date: 01/2025	Project No: S24137	Scale: AS SHOWN

ELECTRICAL- REIDLAND WWTP DEMOLITION AND RELOCATION (PHASE 1)

Drawing No:  
**E1-0**  
Sheet: 4 OF 12

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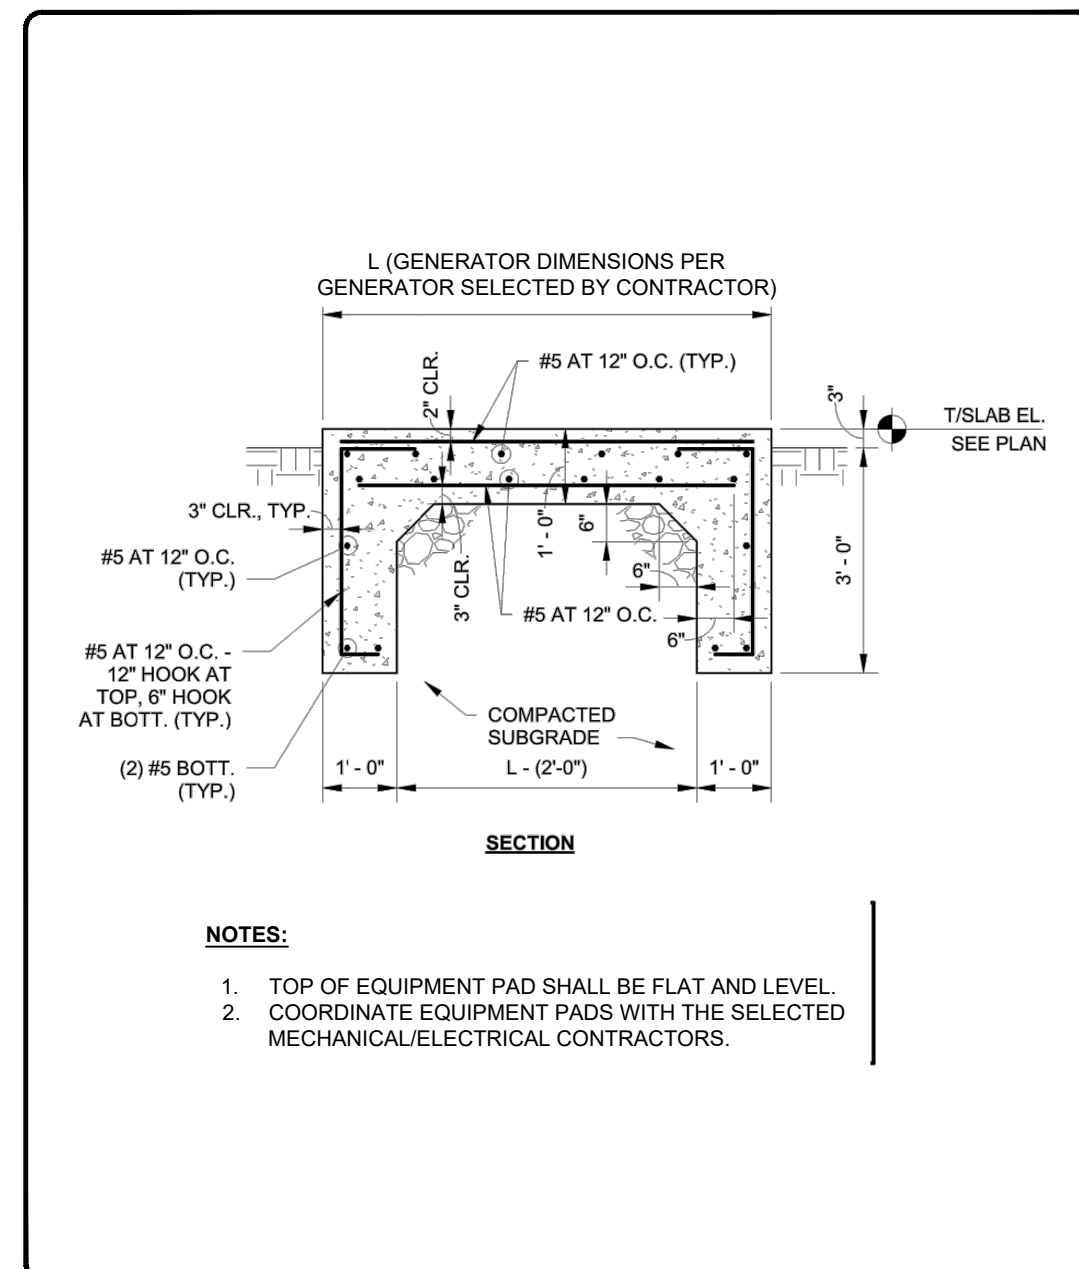
**NOTES:**

- CONTRACTOR SHALL VISIT THE SITE TO BECOME ACQUAINTED WITH ALL PROJECT CONDITIONS INCLUDING EXISTING CONDITIONS. EXECUTION OF CONTRACT IS EVIDENCE THAT THE CONTRACTOR HAS EXAMINED ALL DRAWINGS AND SPECIFICATIONS AND THAT ALL CONDITIONS OF INSTALLING THE WORK IN THIS SECTION ARE VERIFIED. CLAIMS FOR LABOR, MATERIAL, OR TIME EXTENSIONS REQUIRED DUE TO DIFFICULTIES ENCOUNTERED, WHICH COULD HAVE BEEN FORESEEN HAD EXAMINATIONS BEEN MADE, WILL NOT BE RECOGNIZED.
- NEW AUTOMATIC TRANSFER SWITCH TO BE PROVIDED BY CONTRACTOR. CONTRACTOR SHALL COORDINATE WITH ATS MANUFACTURER AND PROVIDE ALL NECESSARY POWER AND CONTROL WIRING FOR A COMPLETE AND FUNCTIONING SYSTEM. LACK OF COORDINATION IS NOT JUSTIFICATION FOR ADDITIONAL FUNDS.
- NEW 200A AUTOMATIC TRANSFER SWITCH PANEL SHALL BE MOUNTED ON A STAINLESS STEEL UNISTRUT MOUNTING STRUCTURE. CONTRACTOR SHALL COORDINATE WITH OWNER FOR FINAL APPROVED LOCATION FOR THE AUTOMATIC TRANSFER SWITCH PANEL.
- A MINIMUM 3' 6" WORKING CLEARANCE IS REQUIRED IN FRONT OF THE CONTROL PANEL PER NEC TABLE 110.26(A)(1).
- THE PUMP STATION WET WELL IS CLASSIFIED AS CLASS 1 DIVISION 1, GROUP D AREA PER NFPA 820. THE AREA WHICH EXTENDS TO 18" ABOVE THE PUMP STATION TOP OF SLAB AND EXTENDS 3' BEYOND ALL SIDES OF THE HATCH IS A CLASS 1, DIVISION 2 HAZARDOUS LOCATION. ANY EQUIPMENT LOCATED WITHIN THE CLASSIFIED AREA SHALL BE UL LISTED FOR THAT AREA. ALL WIRING METHODS SHALL CONFORM TO THE REQUIREMENTS OF NEC ARTICLE 500 AND 501.
- EXISTING 125KW GENERATOR SHALL BE RELOCATED FROM REIDLAND WWTP TO THE PROPOSED LOCATION AT THE DOWNS ROAD LIFT STATION. CONTRACTOR IS RESPONSIBLE FOR ALL COSTS ASSOCIATED WITH THE RELOCATION OF THE GENERATOR.
- CONTRACTOR TO COORDINATE WITH OWNER AND PROVIDE A MINIMUM OF 4FT CLEARANCE ON ALL SIDES OF THE EXISTING 125KW GENERATOR THAT ARE PARALLEL TO THE FENCE.
- CONTRACTOR SHALL COORDINATE WITH ONAN TO ENSURE GENERATOR IS INSTALLED CORRECTLY. CONTRACTOR TO ENSURE THE EXISTING PUMPS LOCATED AT THE DOWNS ROAD LIFT STATION RUN PROPERLY WITH THE GENERATOR INSTALLED.
- CONTRACTOR IS RESPONSIBLE TO RETAP THE CURRENT 240V 3-PHASE SETUP ON THE 125KW GENERATOR TO CONVERT IT TO 480V 3-PHASE TO MATCH THE DOWNS ROAD LIFT STATION FEED REQUIREMENTS. CONTRACTOR IS RESPONSIBLE FOR ALL COSTS ASSOCIATED WITH THE RETAP.
- CONTRACTOR IS RESPONSIBLE TO INSTALL A NEW NEMA 4X 480/120V STEP DOWN TRANSFORMER WITH TWO DEDICATED CIRCUIT BREAKER INSTALLED INSIDE THE CONTROL PANEL. TRANSFORMER SHALL BE MOUNTED EXTERIOR AND ADJACENT TO THE EXISTING LIFT STATION CONTROL PANEL. CONTRACTOR IS RESPONSIBLE TO COORDINATE WITH GENERATOR MANUFACTURER FOR POWER REQUIREMENTS FOR PROPER BREAKER SIZING.




PROPOSED LOCATION OF NEW 200A AUTOMATIC TRANSFER SWITCH

PROPOSED LOCATION OF 125KW GENERATOR



GENERATOR/EQUIPMENT PAD DETAIL

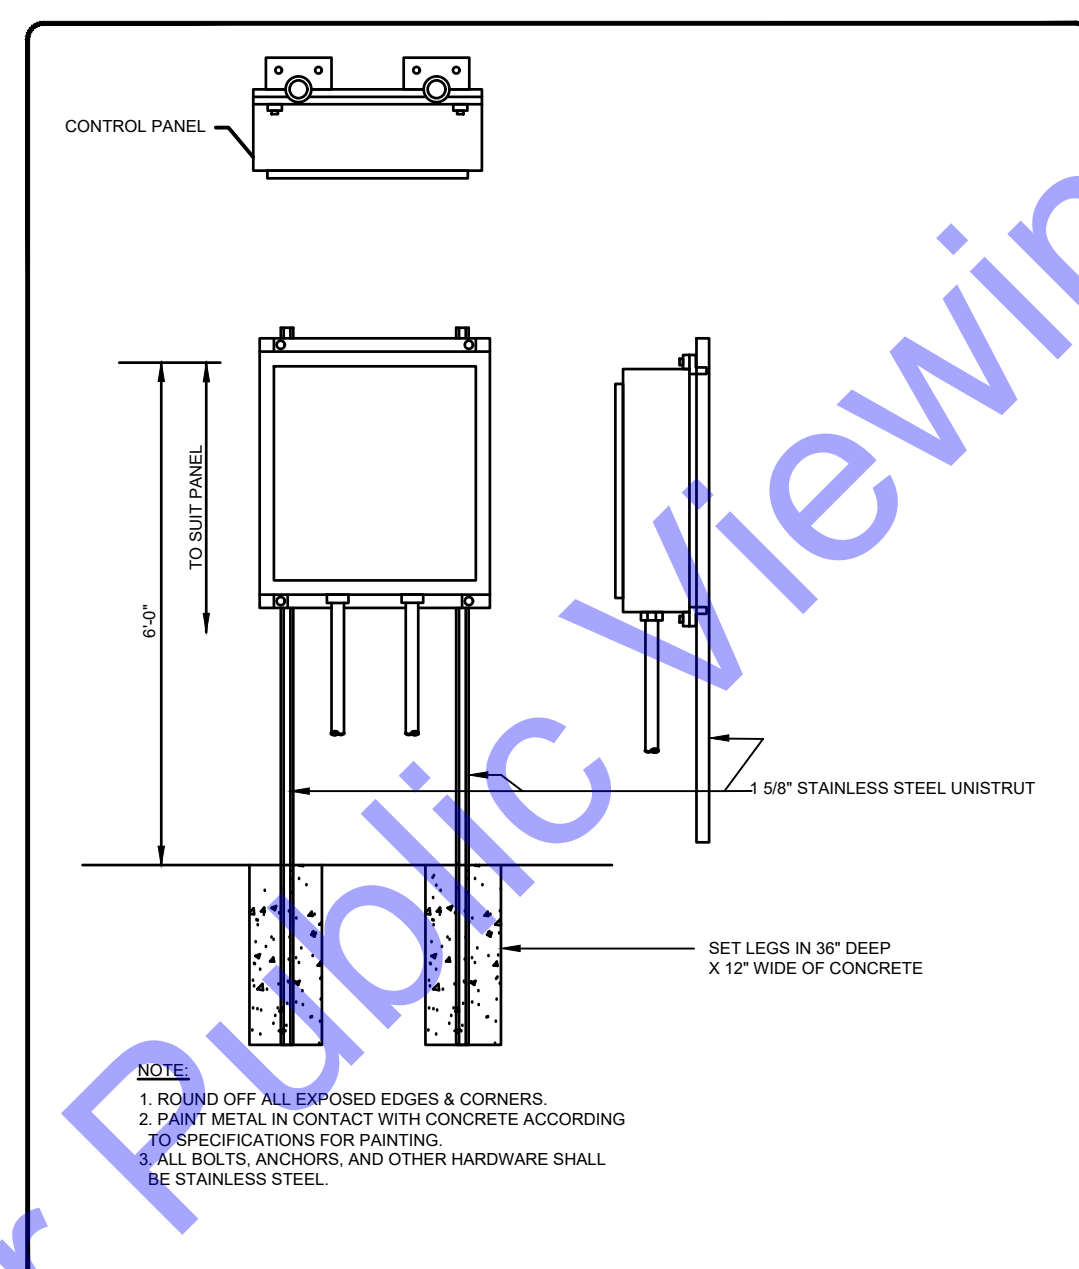

UNISTRUT MOUNT TRANSFER SWITCH PANEL

NOT TO SCALE



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MARK KENNETH NORDMEYER  
30193  
LICENSED PROFESSIONAL ENGINEER

*Mark Nordmeyer*  
Signature Date 1/13/2025

PADUCAH MCCrackEN COUNTY  
JOINT SEWER AGENCY  
PADUCAH, KENTUCKY  
GENERATORS AND AUTOMATIC TRANSFER SWITCHES  
JANUARY 2025  
PHASE 1 & PHASE 2

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Issue Date:	Project No:	Scale:
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ELECTRICAL - DOWNS ROAD LIFT STATION (PHASE 1)

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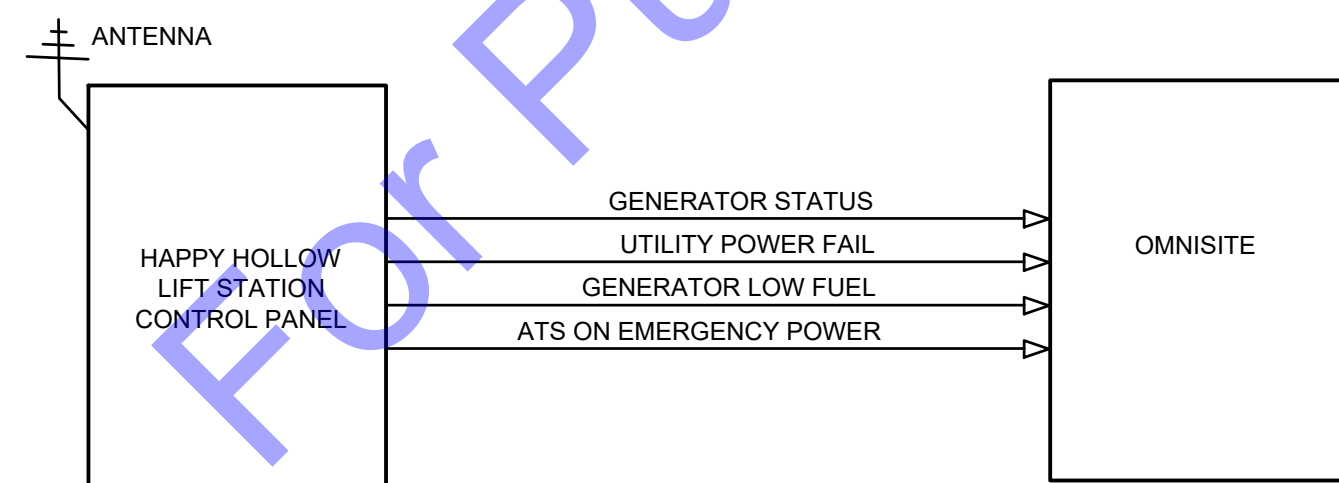
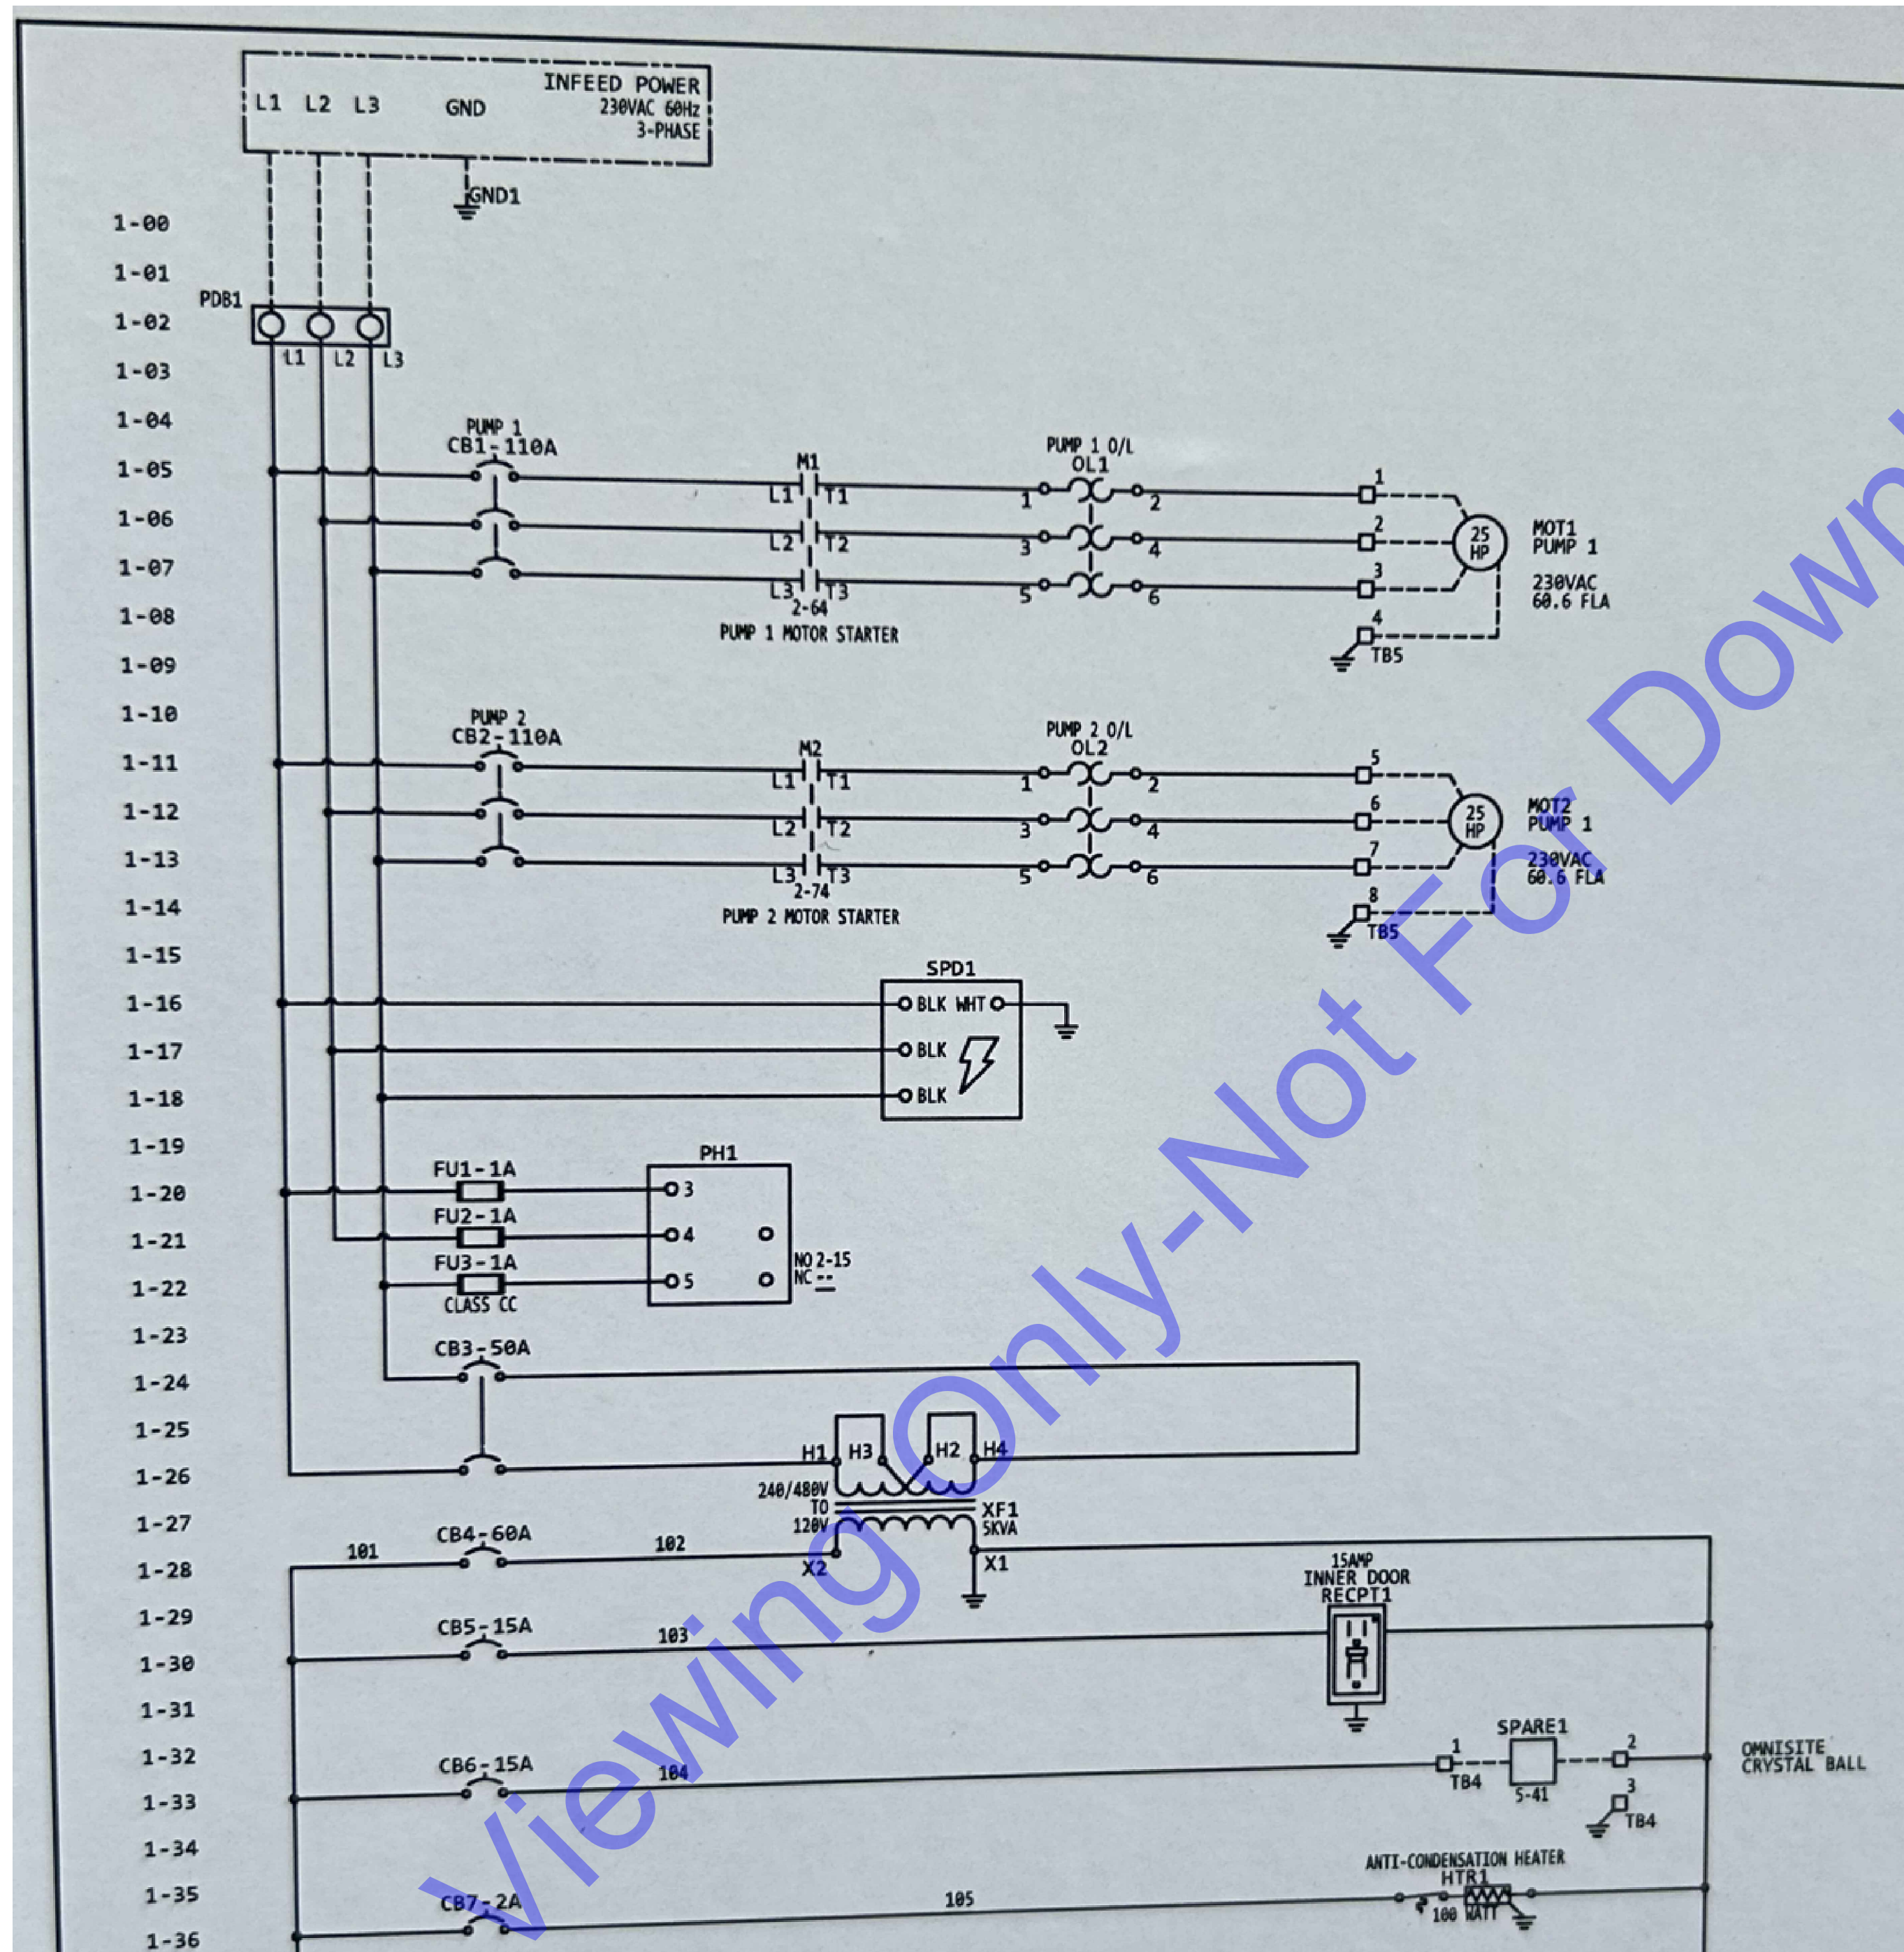
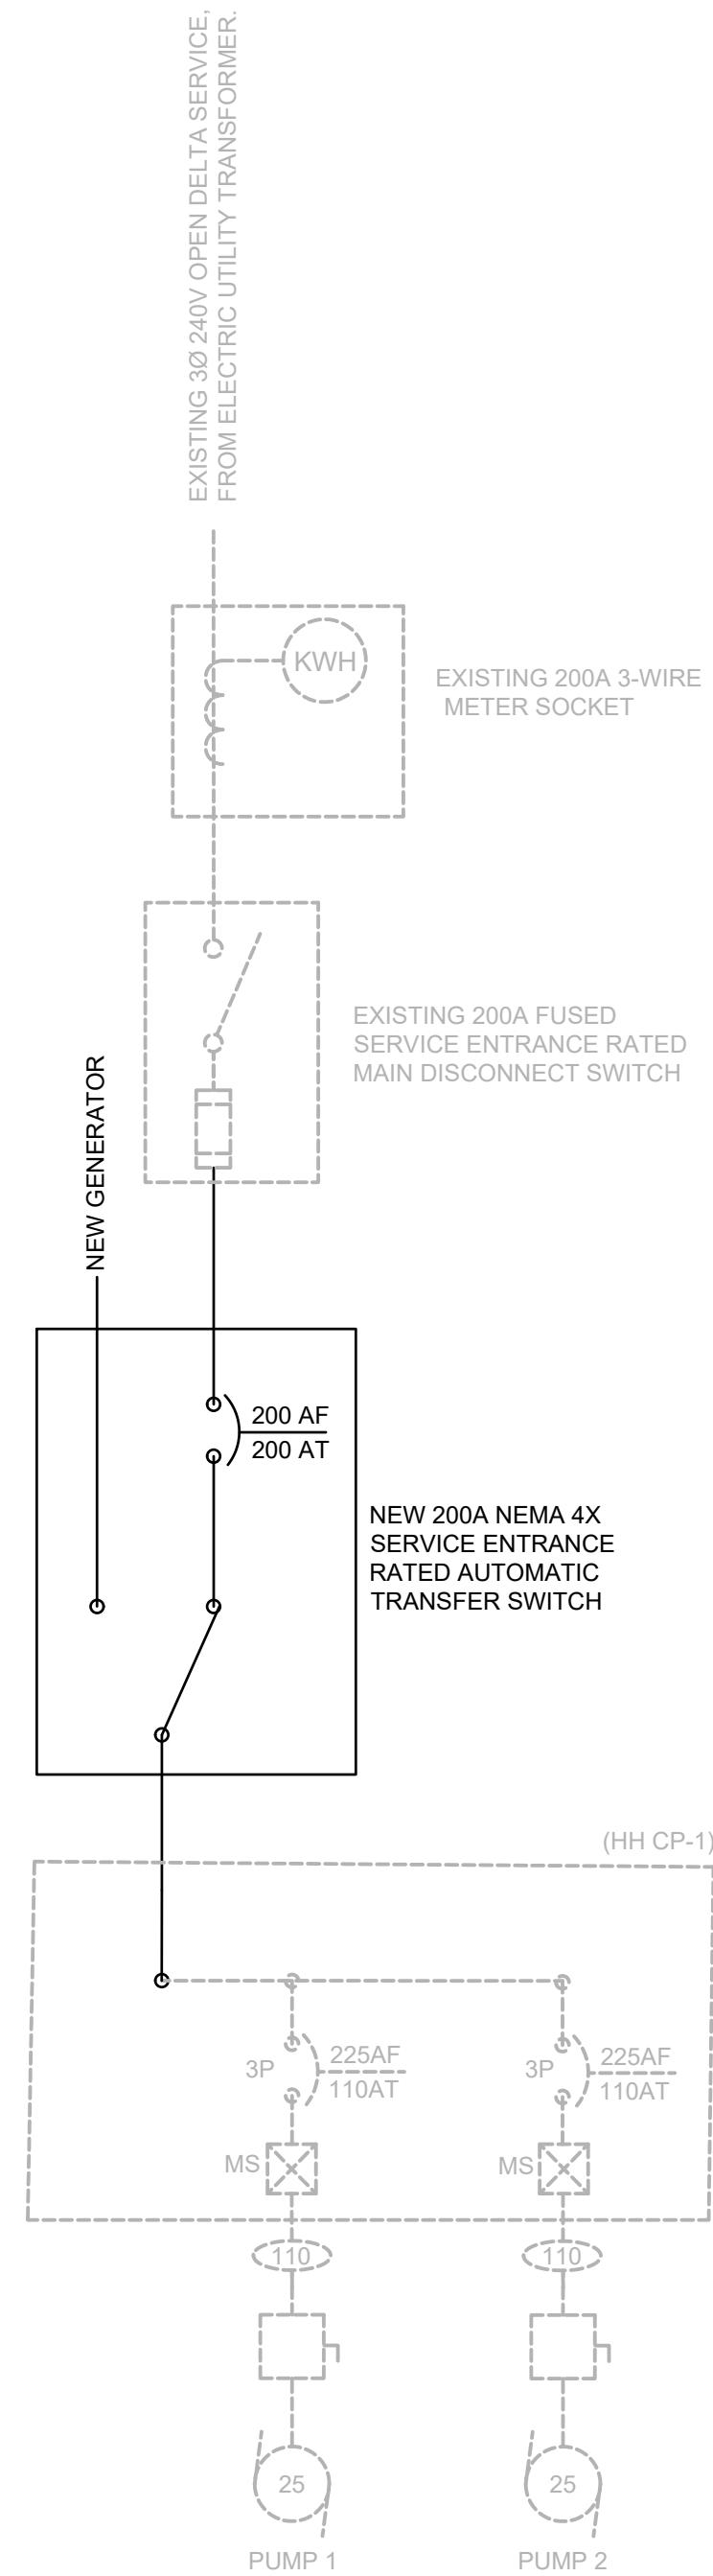












NOTES:

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- NEW AUTOMATIC TRANSFER SWITCH TO BE PROVIDED BY CONTRACTOR. CONTRACTOR SHALL COORDINATE WITH ATS MANUFACTURER AND PROVIDE ALL NECESSARY POWER AND CONTROL WIRING FOR A COMPLETE AND FUNCTIONING SYSTEM. LACK OF COORDINATION IS NOT JUSTIFICATION FOR ADDITIONAL FUNDS.
- A MINIMUM 3' 6" WORKING CLEARANCE IS REQUIRED IN FRONT OF THE CONTROL PANEL PER NEC TABLE 110.26(A)(1).
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- CONTRACTOR SHALL COORDINATE WITH CUMMINS OR ENGINEER APPROVED EQUAL MANUFACTURER TO ENSURE THE NEW 60KW GENERATOR IS INSTALLED CORRECTLY. CONTRACTOR TO ENSURE THE EXISTING PUMPS LOCATED AT THE DOWNS ROAD LIFT STATION RUN PROPERLY WITH THE GENERATOR INSTALLED.
- CONTRACTOR IS RESPONSIBLE TO INSTALL A NEW NEMA 3R 240/120V STEP DOWN TRANSFORMER WITH TWO DEDICATED CIRCUIT BREAKER INSTALLED INSIDE THE PANEL. TRANSFORMER SHALL BE MOUNTED EXTERIOR AND ADJACENT TO THE EXISTING LIFT STATION CONTROL PANEL. CONTRACTOR IS RESPONSIBLE TO COORDINATE WITH GENERATOR MANUFACTURER FOR POWER REQUIREMENTS FOR PROPER BREAKER SIZING.
- CONTRACTOR IS RESPONSIBLE TO PROVIDE CONDUIT AND WIRE FOR GENERATOR AND AUTOMATIC TRANSFER SWITCH ALARMS. CONTRACTOR IS RESPONSIBLE TO PROVIDE CONDUIT, WIRE, AND TERMINATION AT THE GENERATOR AND AUTOMATIC TRANSFER SWITCH FOR ALL AVAILABLE ALARMS AND CONNECT TO THE OMNISTE DIALER. OPERATOR IS RESPONSIBLE TO PROVIDE TERMINATORS AT THE OMNISTE PANEL. CONTRACTOR SHALL TAG WIRES AND NOTE WHAT ALARMS ARE CONNECTED FOR OPERATOR.



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				01/2025	S24137	AS SHOWN






PROPOSED LOCATION OF NEW 200A AUTOMATIC TRANSFER SWITCH


PROPOSED LOCATION OF NEW 50KW GENERATOR

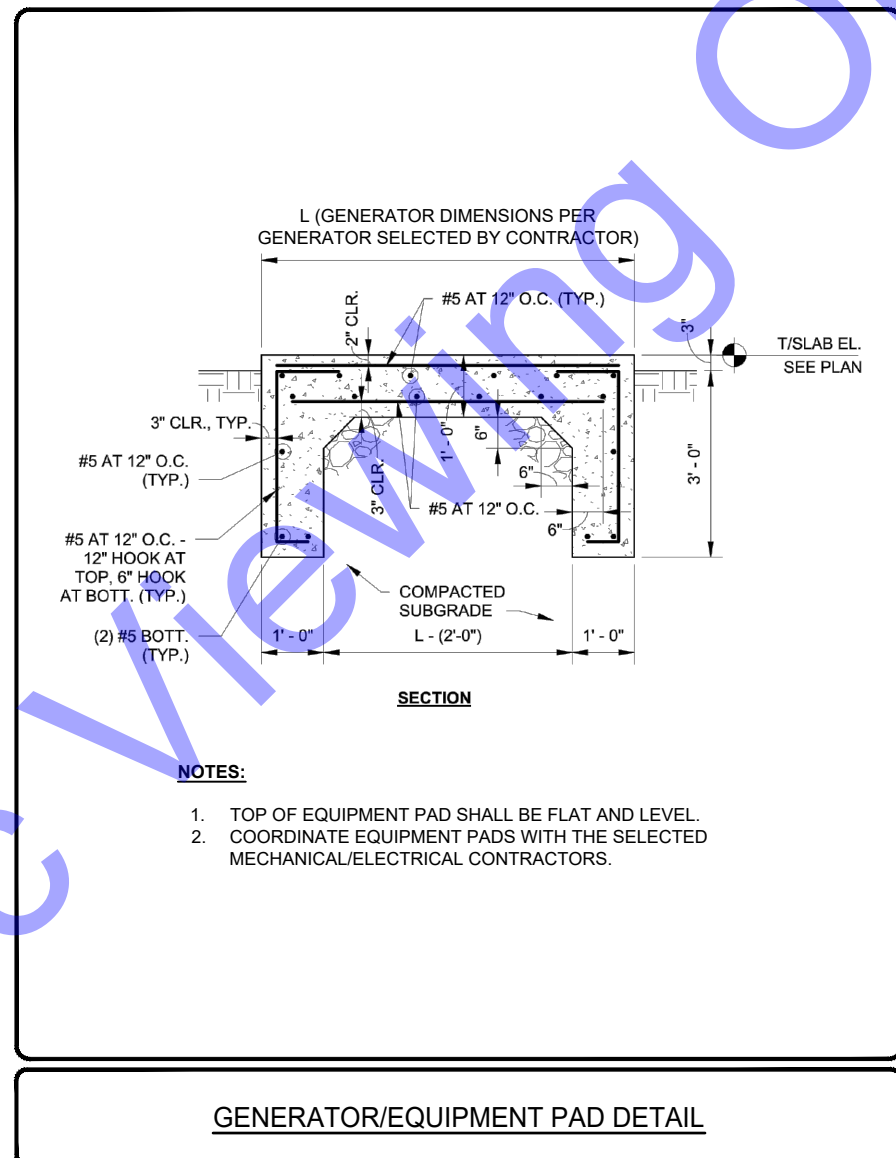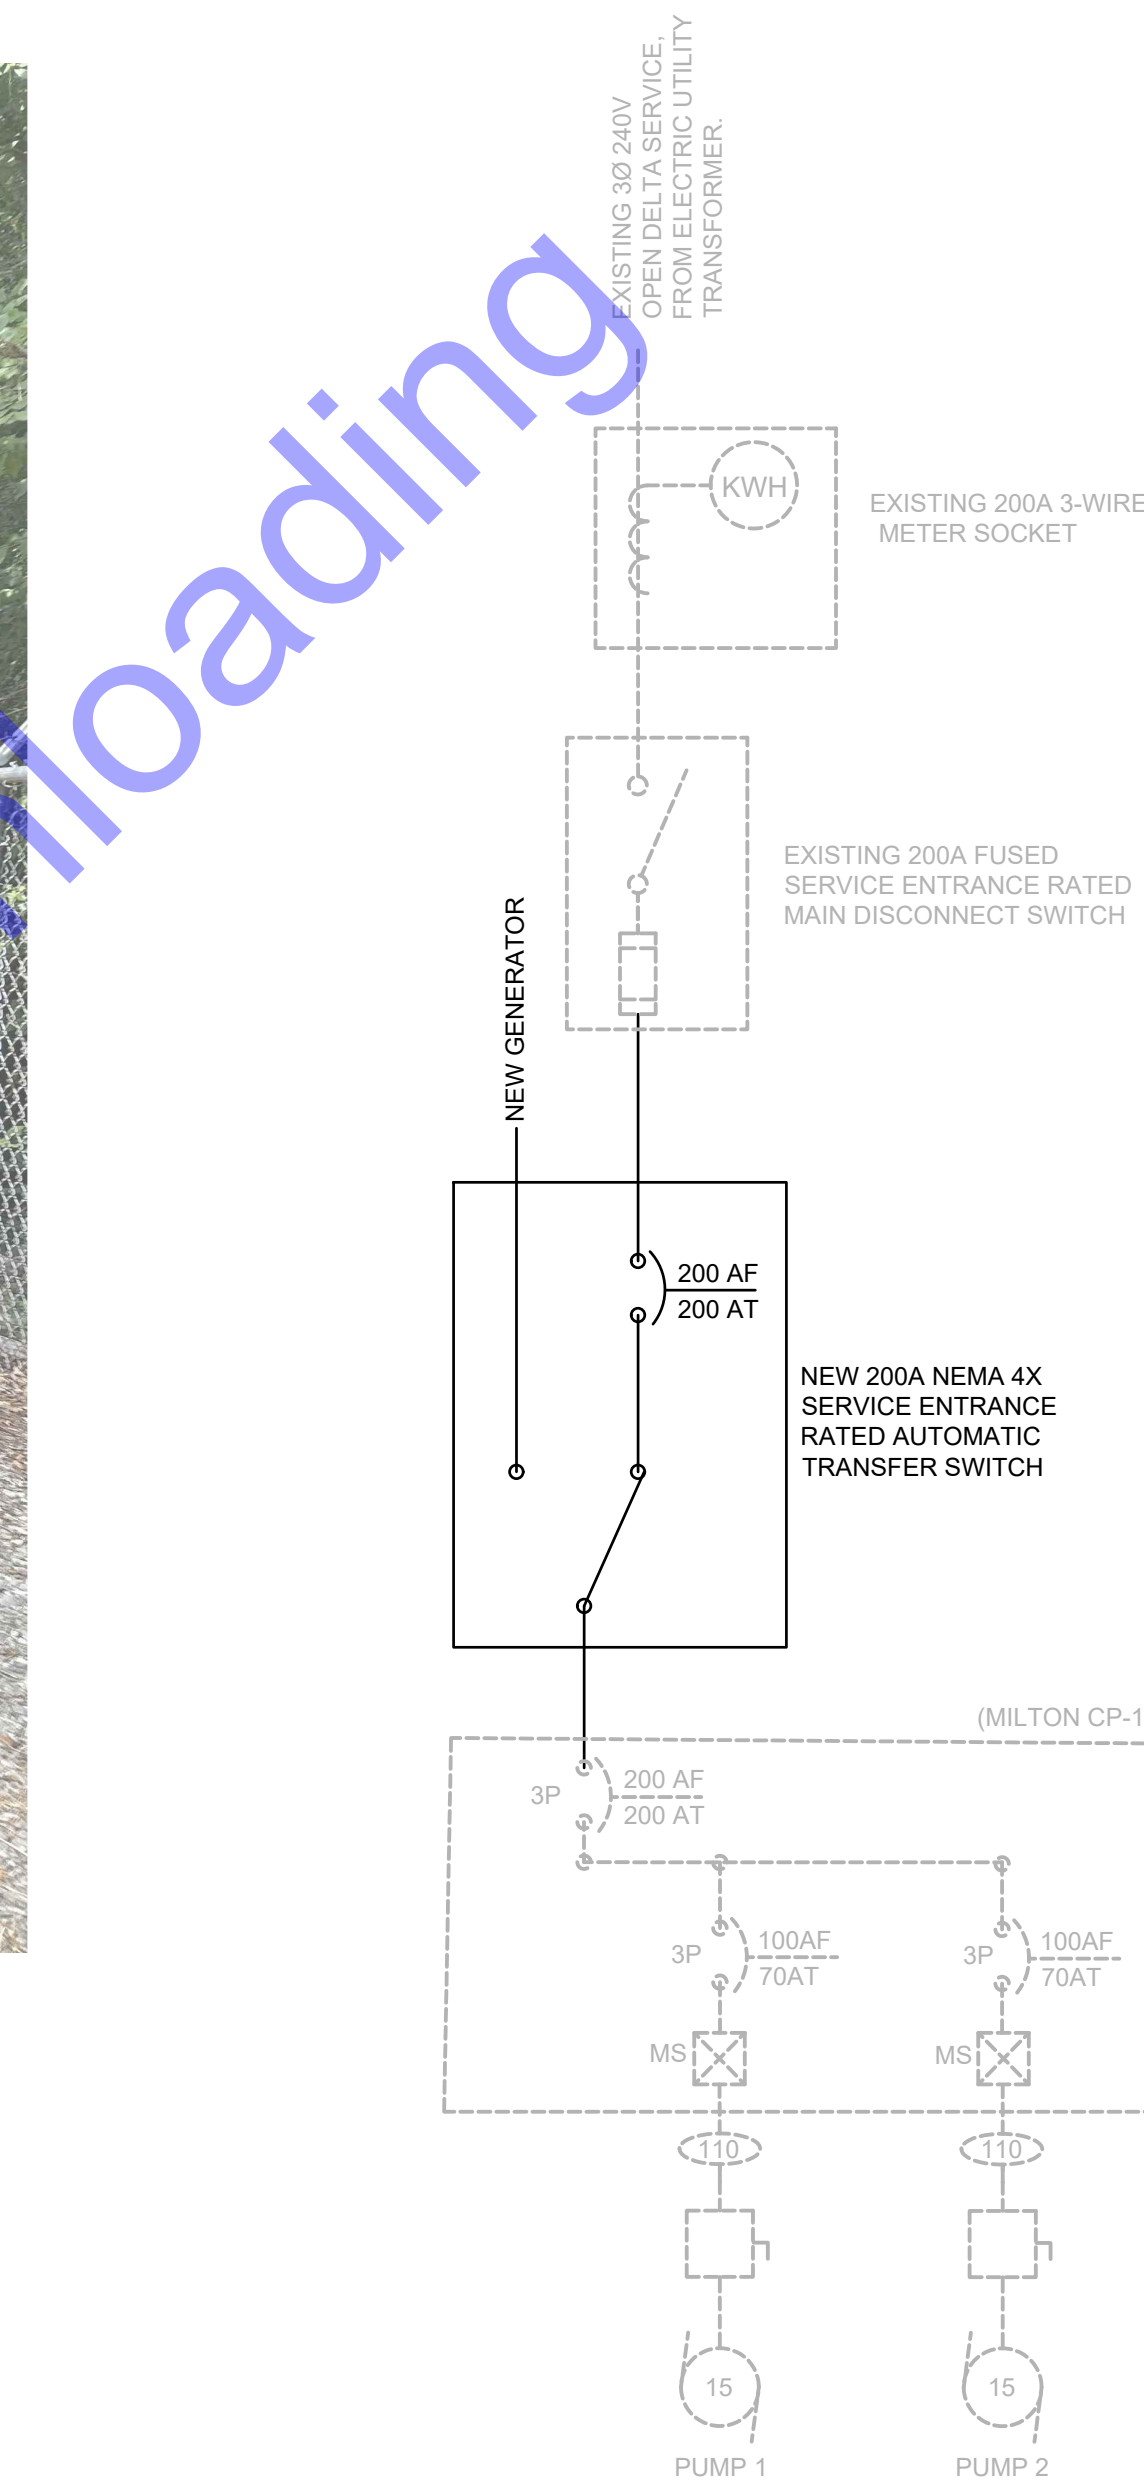

GENERATOR/EQUIPMENT PAD DETAIL

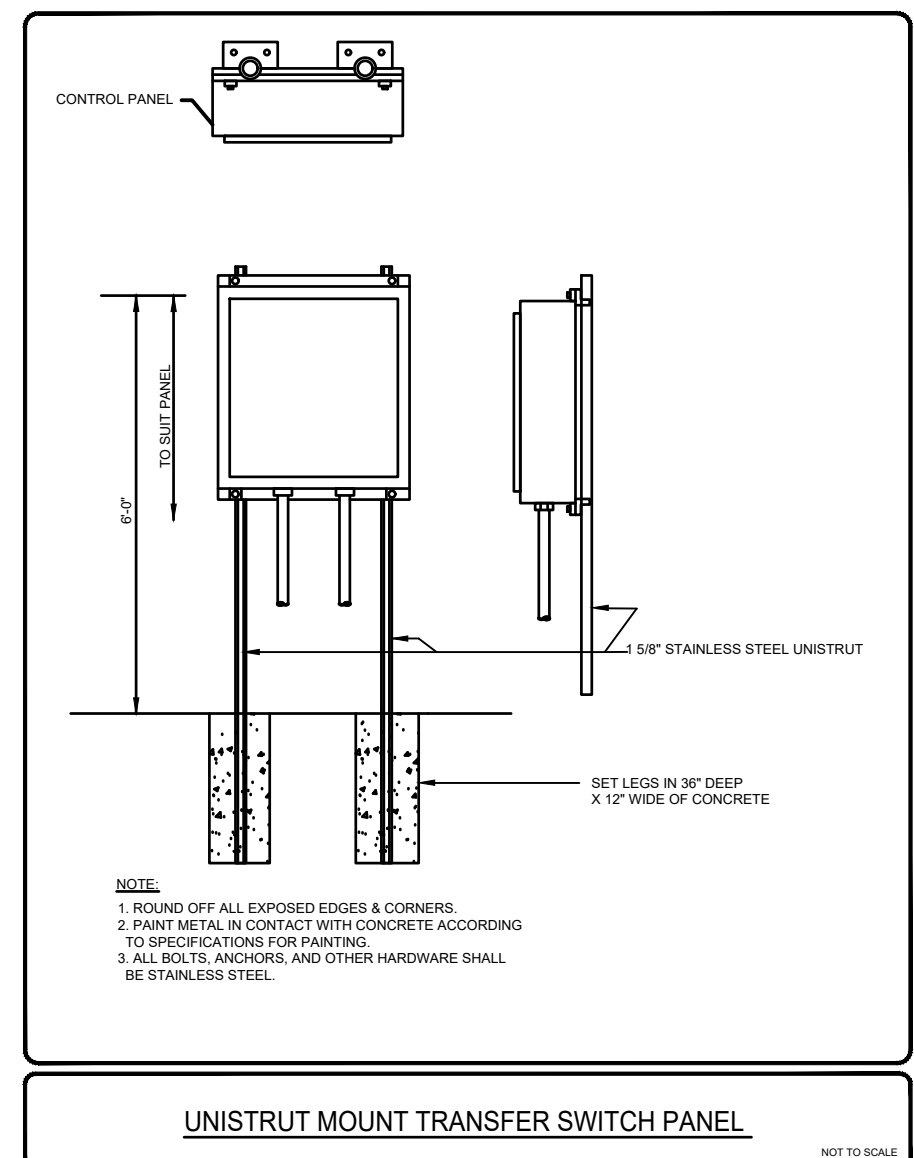

UNISTRUT MOUNT TRANSFER SWITCH PANEL

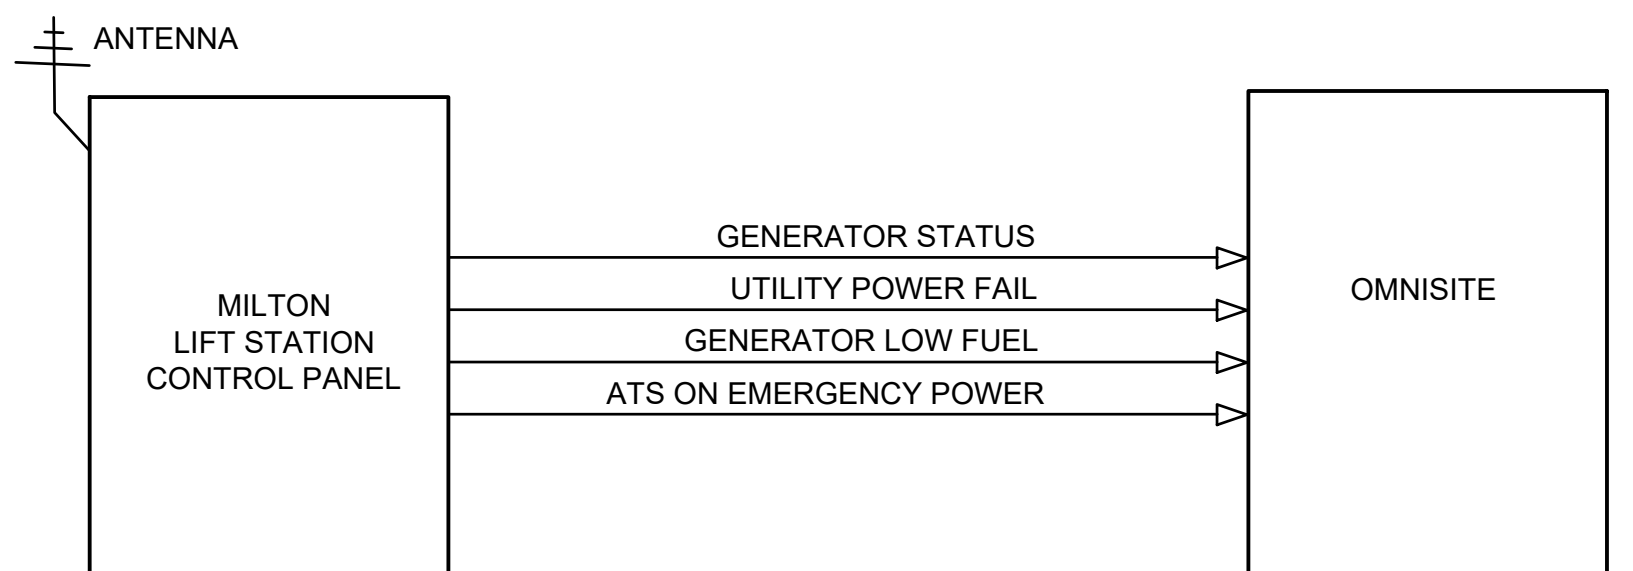

NOTES:

- CONTRACTOR SHALL VISIT THE SITE TO BECOME ACQUAINTED WITH ALL PROJECT CONDITIONS INCLUDING EXISTING CONDITIONS. EXECUTION OF CONTRACT IS EVIDENCE THAT THE CONTRACTOR HAS EXAMINED ALL DRAWINGS AND SPECIFICATIONS AND THAT ALL CONDITIONS OF INSTALLING THE WORK IN THIS SECTION ARE VERIFIED. CLAIMS FOR LABOR, MATERIAL, OR TIME EXTENSIONS REQUIRED DUE TO DIFFICULTIES ENCOUNTERED, WHICH COULD HAVE BEEN FORESEEN HAD EXAMINATIONS BEEN MADE, WILL NOT BE RECOGNIZED.
- NEW AUTOMATIC TRANSFER SWITCH TO BE PROVIDED BY CONTRACTOR. CONTRACTOR SHALL COORDINATE WITH ATS MANUFACTURER AND PROVIDE ALL NECESSARY POWER AND CONTROL WIRING FOR A COMPLETE AND FUNCTIONING SYSTEM. LACK OF COORDINATION IS NOT JUSTIFICATION FOR ADDITIONAL FUNDS.
- NEW 200A AUTOMATIC TRANSFER SWITCH PANEL SHALL BE MOUNTED ON A STAINLESS STEEL UNISTRUT MOUNTING STRUCTURE. CONTRACTOR SHALL COORDINATE WITH OWNER FOR FINAL APPROVED LOCATION FOR THE AUTOMATIC TRANSFER SWITCH PANEL.
- A MINIMUM 3' 6" WORKING CLEARANCE IS REQUIRED IN FRONT OF THE CONTROL PANEL PER NEC TABLE 110.26(A)(1).
- THE PUMP STATION WET WELL IS CLASSIFIED AS CLASS 1 DIVISION 1, GROUP D AREA PER NFPA 820. THE AREA WHICH EXTENDS TO 18" ABOVE THE PUMP STATION TOP OF SLAB AND EXTENDS 3' BEYOND ALL SIDES OF THE HATCH IS A CLASS 1, DIVISION 2 HAZARDOUS LOCATION. ANY EQUIPMENT LOCATED WITHIN THE CLASSIFIED AREA SHALL BE UL LISTED FOR THAT AREA. ALL WIRING METHODS SHALL CONFORM TO THE REQUIREMENTS OF NEC ARTICLE 500 AND 501.
- CONTRACTOR SHALL COORDINATE WITH CUMMINS OR ENGINEER APPROVED EQUAL MANUFACTURER TO ENSURE THE NEW 50KW GENERATOR IS INSTALLED CORRECTLY. CONTRACTOR TO ENSURE THE EXISTING PUMPS LOCATED AT THE DOWNS ROAD LIFT STATION RUN PROPERLY WITH THE GENERATOR INSTALLED.
- CONTRACTOR TO COORDINATE WITH OWNER AND PROVIDE A MINIMUM OF 4FT CLEARANCE ON ALL SIDES OF THE NEW 50KW GENERATOR THAT ARE PARALLEL TO THE FENCE.
- CONTRACTOR IS RESPONSIBLE TO INSTALL A NEW NEMA 4X 240/120V STEP DOWN TRANSFORMER WITH TWO DEDICATED CIRCUIT BREAKER INSTALLED INSIDE THE CONTROL PANEL. TRANSFORMER SHALL BE MOUNTED EXTERIOR AND ADJACENT TO THE EXISTING LIFT STATION CONTROL PANEL. CONTRACTOR IS RESPONSIBLE TO COORDINATE WITH GENERATOR MANUFACTURER FOR POWER REQUIREMENTS FOR PROPER BREAKER SIZING.
- CONTRACTOR IS RESPONSIBLE TO PROVIDE CONDUIT AND WIRE FOR GENERATOR AND AUTOMATIC TRANSFER SWITCH ALARMS. CONTRACTOR IS RESPONSIBLE TO PROVIDE CONDUIT, WIRE, AND TERMINATION AT THE GENERATOR AND AUTOMATIC TRANSFER SWITCH FOR ALL AVAILABLE ALARMS AND CONNECT TO THE OMNISITE DIALER. OPERATOR IS RESPONSIBLE TO PROVIDE TERMINATORS AT THE OMNISITE PANEL. CONTRACTOR SHALL TAG WIRES AND NOTE WHAT ALARMS ARE CONNECTED FOR OPERATOR.

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STATE OF KENTUCKY  
 MARK KENNETH NORDMEYER  
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**PADUCAH MCCracken COUNTY  
 JOINT SEWER AGENCY  
 PADUCAH, KENTUCKY**  
**GENERATORS AND AUTOMATIC  
 TRANSFER SWITCHES  
 JANUARY 2025  
 PHASE 1 & PHASE 2**

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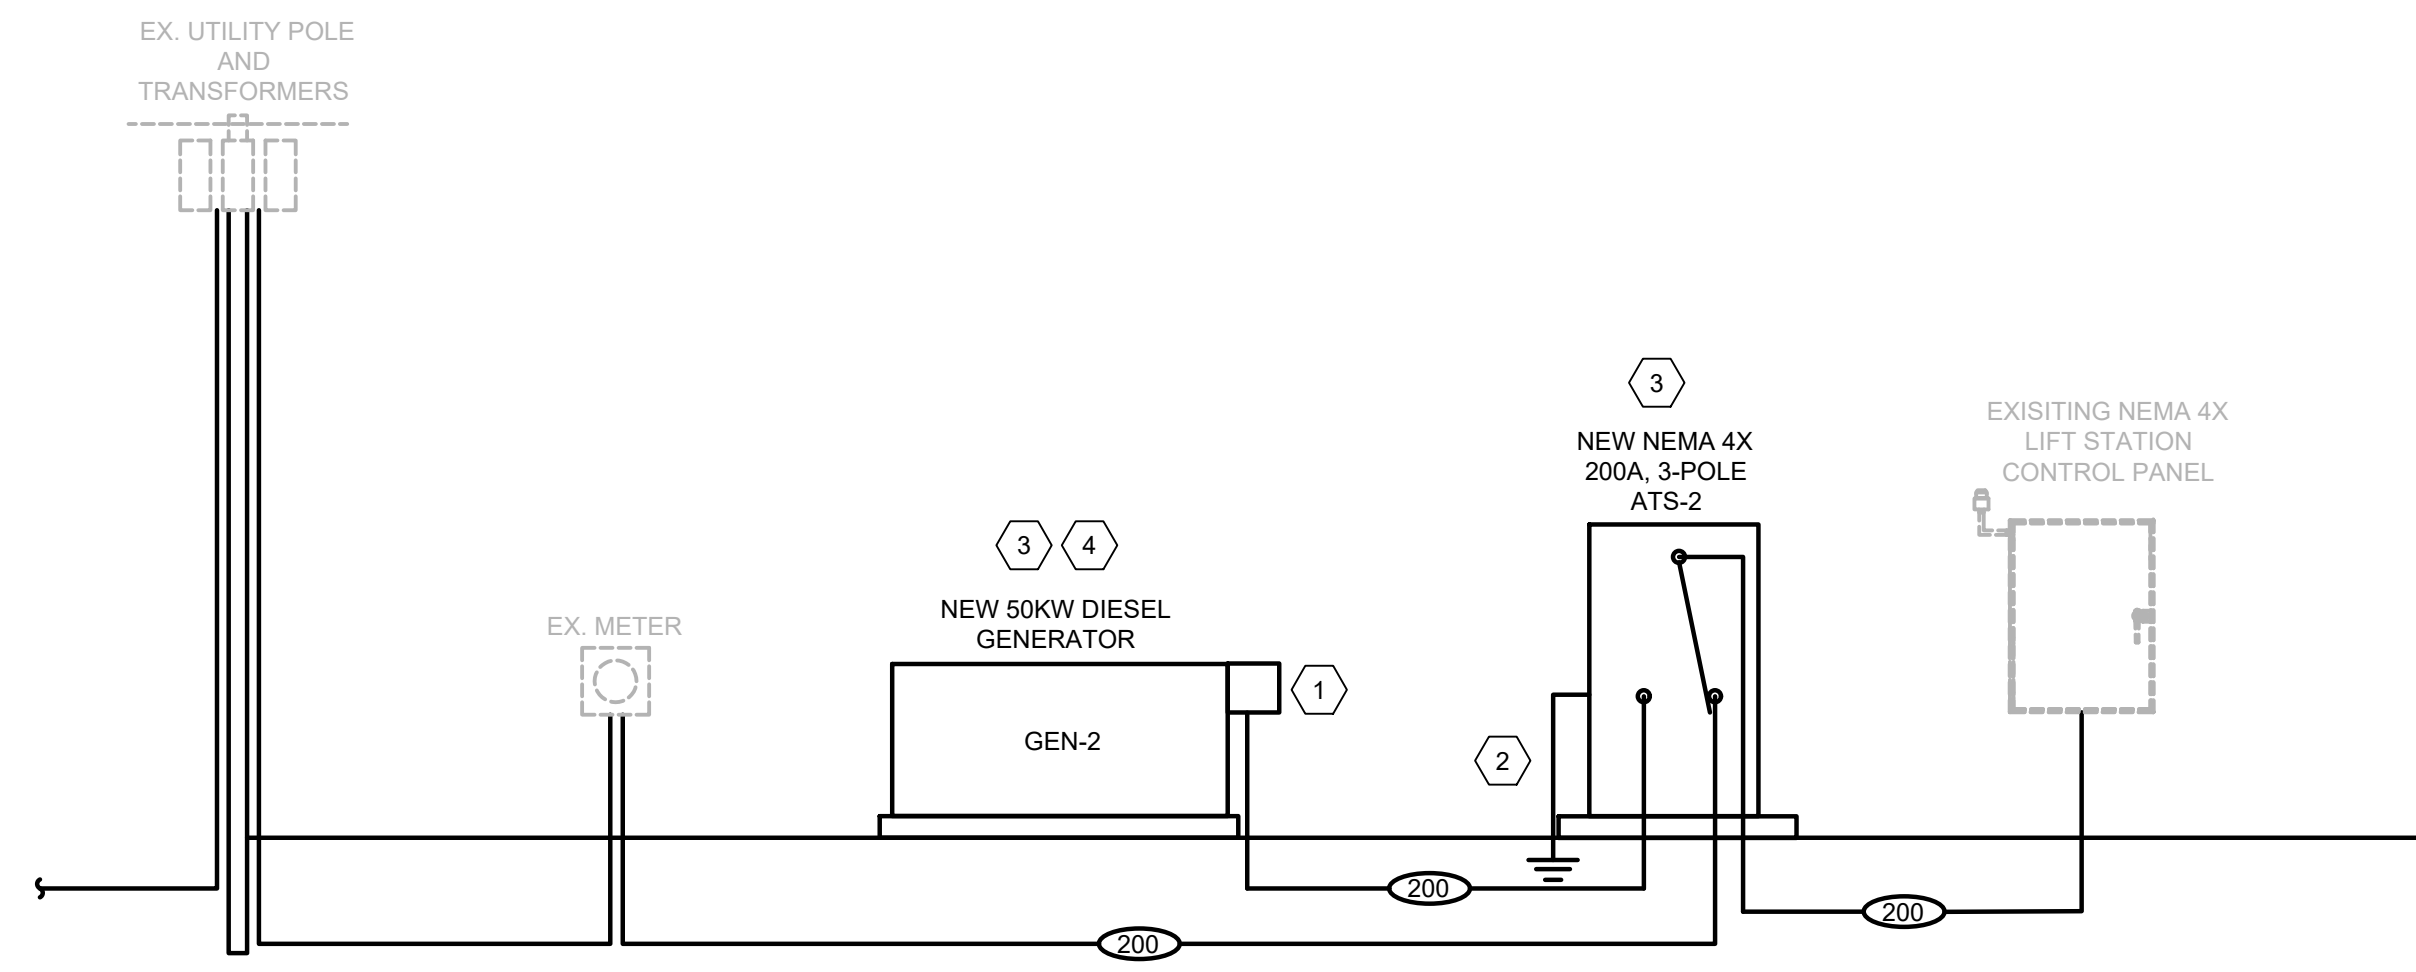
No.	Submission / Revision	Date	By

Designed By: JTS	Drawn By: JTS	Checked By: TLC
Issue Date: 01/2025	Project No: S24137	Scale: AS SHOWN

**ELECTRICAL - MILTON  
 LIFT STATION SITE  
 PLAN AND ONE-LINE  
 DIAGRAM (PHASE 2)**

Drawing No:  
**E3-0**  
 Sheet: 11 OF 12





**PLAN NOTES**

- 1 CONTRACTOR IS RESPONSIBLE TO PROVIDE GENERATOR INTEGRAL CIRCUIT BREAKER TO PROVIDE MEANS OF CURRENT PROTECTION AND DISCONNECTION AT THE GENERATOR. CONTRACTOR SHALL COORDINATE WITH GENERATOR MANUFACTURER TO ENSURE THE PROPER SIZED CIRCUIT BREAKER IS PROVIDED.
- 2 PROVIDE TRIAD GROUNDING SYSTEM.
- 3 COORDINATE WITH GENERATOR AND ATS SUPPLIER/MANUFACTURER FOR WIRING REQUIREMENTS DURING BIDDING AND CONSTRUCTION.
- 4 VERIFY THAT THE NEUTRAL TO GROUND IS NOT BONDED AT GENERATOR BY THE GENERATOR MANUFACTURER.
- 5 CONTRACTOR SHALL COORDINATE WITH GENERATOR MANUFACTURER AND IS RESPONSIBLE FOR NEW BREAKER TO FEED GENERATOR ANCILLARY DEVICES.

- NOTES:**
1. SEE E0.0 FOR PROJECT CONDUIT REQUIREMENTS.

FEEDER SCHEDULE					
TYPE NO.	COPPER WIRE		CONDUIT	W/O NEUTRAL	SERVICE GROUND
	QUANTITIES	WIRE SIZE			
15	4#12	#12 GROUND	3/4"	3/4"	#6
20	4#12	#12 GROUND	3/4"	3/4"	#6
30	4#10	#10 GROUND	3/4"	3/4"	#6
50	4#8	#10 GROUND	1"	1"	#8
65	4#6	#8 GROUND	1-1/4"	1-1/4"	#8
85	4#4	#8 GROUND	1-1/4"	1-1/4"	#8
100	4#3	#8 GROUND	1-1/2"	1-1/4"	#8
115	4#2	#6 GROUND	1-1/2"	1-1/2"	#8
130	4#1	#6 GROUND	2"	1-1/2"	#6
150	4#1/0	#6 GROUND	2"	2"	#6
175	4#2/0	#6 GROUND	2"	2"	#4
200	4#3/0	#6 GROUND	2-1/2"	2"	#4
225	4#4/0	#4 GROUND	2-1/2"	2-1/2"	#2
250	4#250MCM	#4 GROUND	3"	2-1/2"	#2
300	4#350MCM	#3 GROUND	3"	3"	#2
380	4#500MCM	#3 GROUND	4"	4"	#1/0
420	4#600MCM	#2 GROUND	4"	4"	#1/0
460	(2 SETS) 4#4/0	#2 GROUND	2-1/2"	2-1/2"	#1/0
500	(2 SETS) 4#250MCM	#2 GROUND	4"	3"	#1/0
600	(2 SETS) 4#350MCM	#1 GROUND	4"	3"	#2/0
700	(2 SETS) 4#500MCM	#1/0 GND	4"	4"	#2/0
800	(3 SETS) 4#300MCM	#1/0 GND	3"	3"	#2/0
1000	(3 SETS) 4#500MCM	#2/0 GND	4"	4"	#3/0
1200	(4 SETS) 4#350 MCM	#3/0 GND	4"	4"	#3/0
1600	(5 SETS) 4#600 MCM	#3/0 GND	4"	3 1/2"	#3/0
2000	(6 SETS) 4#600MCM	#3/0 GND	4"	3 1/2"	#3/0

ALL FEEDERS ARE ASSUMED TO BE 4 CURRENT CARRYING CONDUCTORS (3 PHASE CONDUCTORS AND 1 NEUTRAL) UNLESS NOTED OTHERWISE.

FEEDER KEY IS AS FOLLOWS (PARENTHESIS DENOTES SUBSCRIPT):  
 ### = 3 PHASES AND NEUTRAL WITH GROUND  
 ###(N) = 3 PHASES, NO NEUTRAL WITH GROUND  
 ###(2) = 2 PHASES AND NEUTRAL WITH GROUND  
 ALL CIRCUITS SHALL BE RUN IN PVC BELOW GROUND/ PVC COATED RIGID ABOVE GROUND

**GENERATOR** (3) (4)

MINIMUM RATED CAPACITY: 50 KW

BASIS OF DESIGN: MANUFACTURER: CUMMINS      MODEL: C50D6 OR EQUAL MEETING SPECIFICATIONS

RATED VOLTAGE: 120/240V    3 PHASE/4-WIRE

ENCLOSURE RATING: SEE SPECIFICATIONS      FUEL TYPE: DIESEL

FUEL TANK CAPACITY: 24 HOURS

SEE SPECIFICATIONS FOR ADDITIONAL FEATURES

**NEMA 4X TRANSFER SWITCH** (3)

TRANSFER SWITCH TYPE: AUTOMATIC      CURRENT RATING: 200 A

RATED VOLTAGE: 240V    3 PHASE/4-WIRE      # OF POLES: 3

NEUTRAL CONFIGURATION: SOLID      IN-SYNC TRANSFER: YES





MAIN CIRCUIT BREAKER: 200 A      GROUND FAULT ON MAIN: YES

SERVICE ENTRANCE RATED: YES      REMOTE ANNUNCIATION: NO

BY-PASS/ISOLATION: NO      NEC LOAD BRANCH: 702      KAIC: 22 (CONTRACTOR TO CONFIRM W/ UTILITY)

SEE SPECIFICATIONS FOR ADDITIONAL FEATURES

NEMA RATING: NEMA 4X      CYCLE RATING: 3

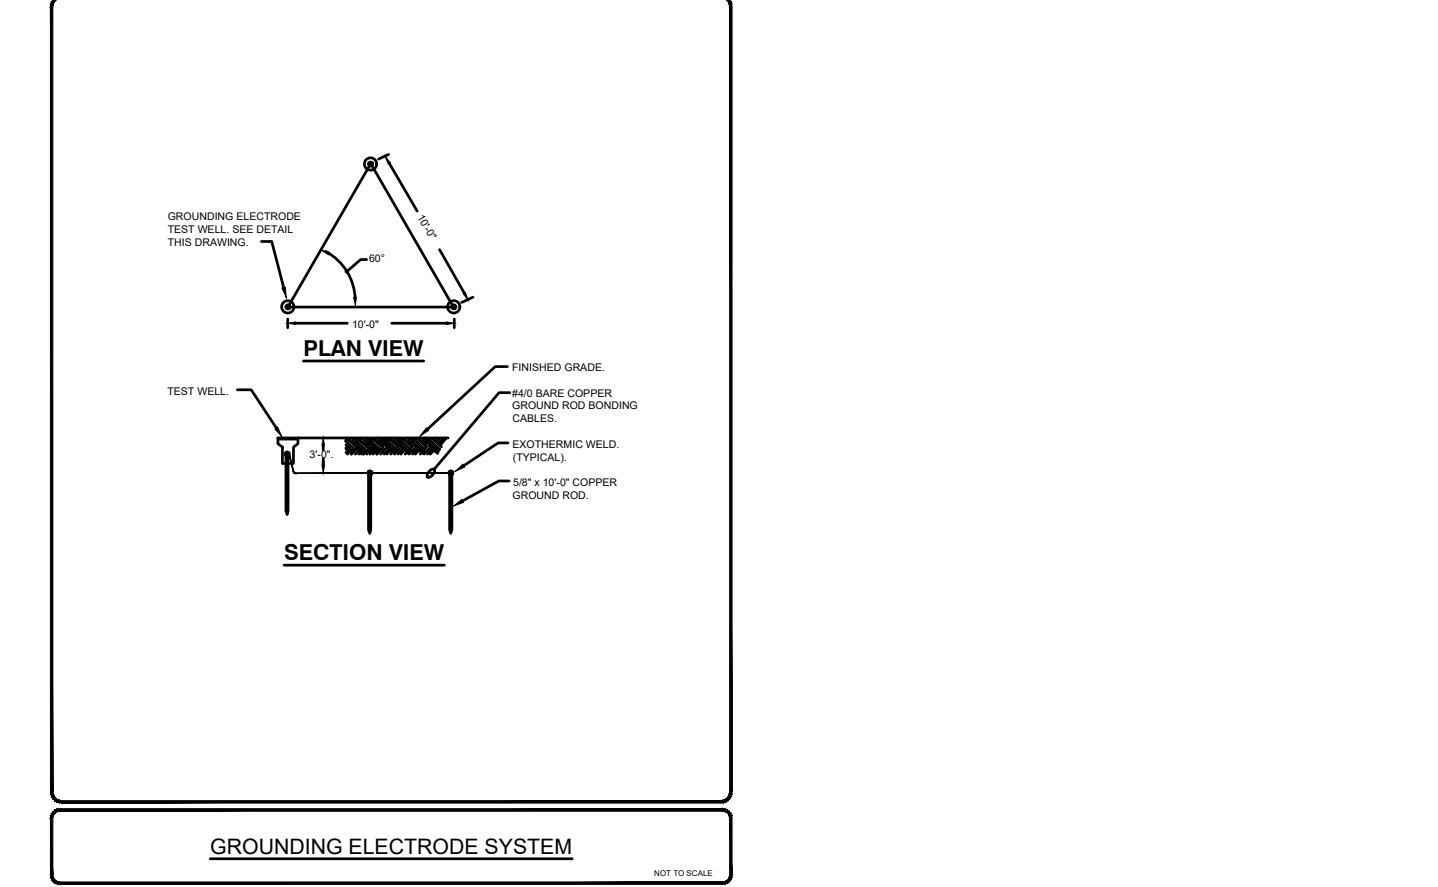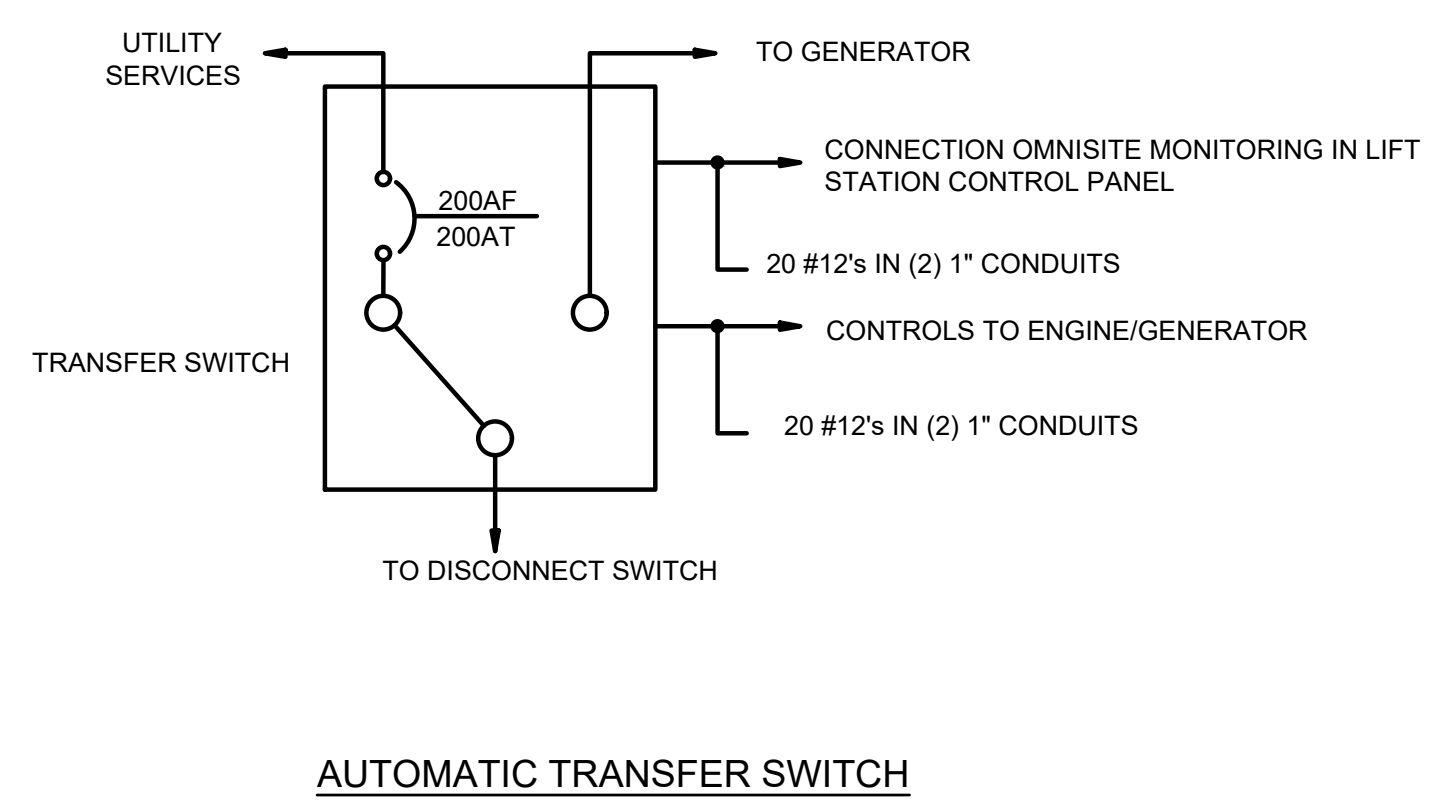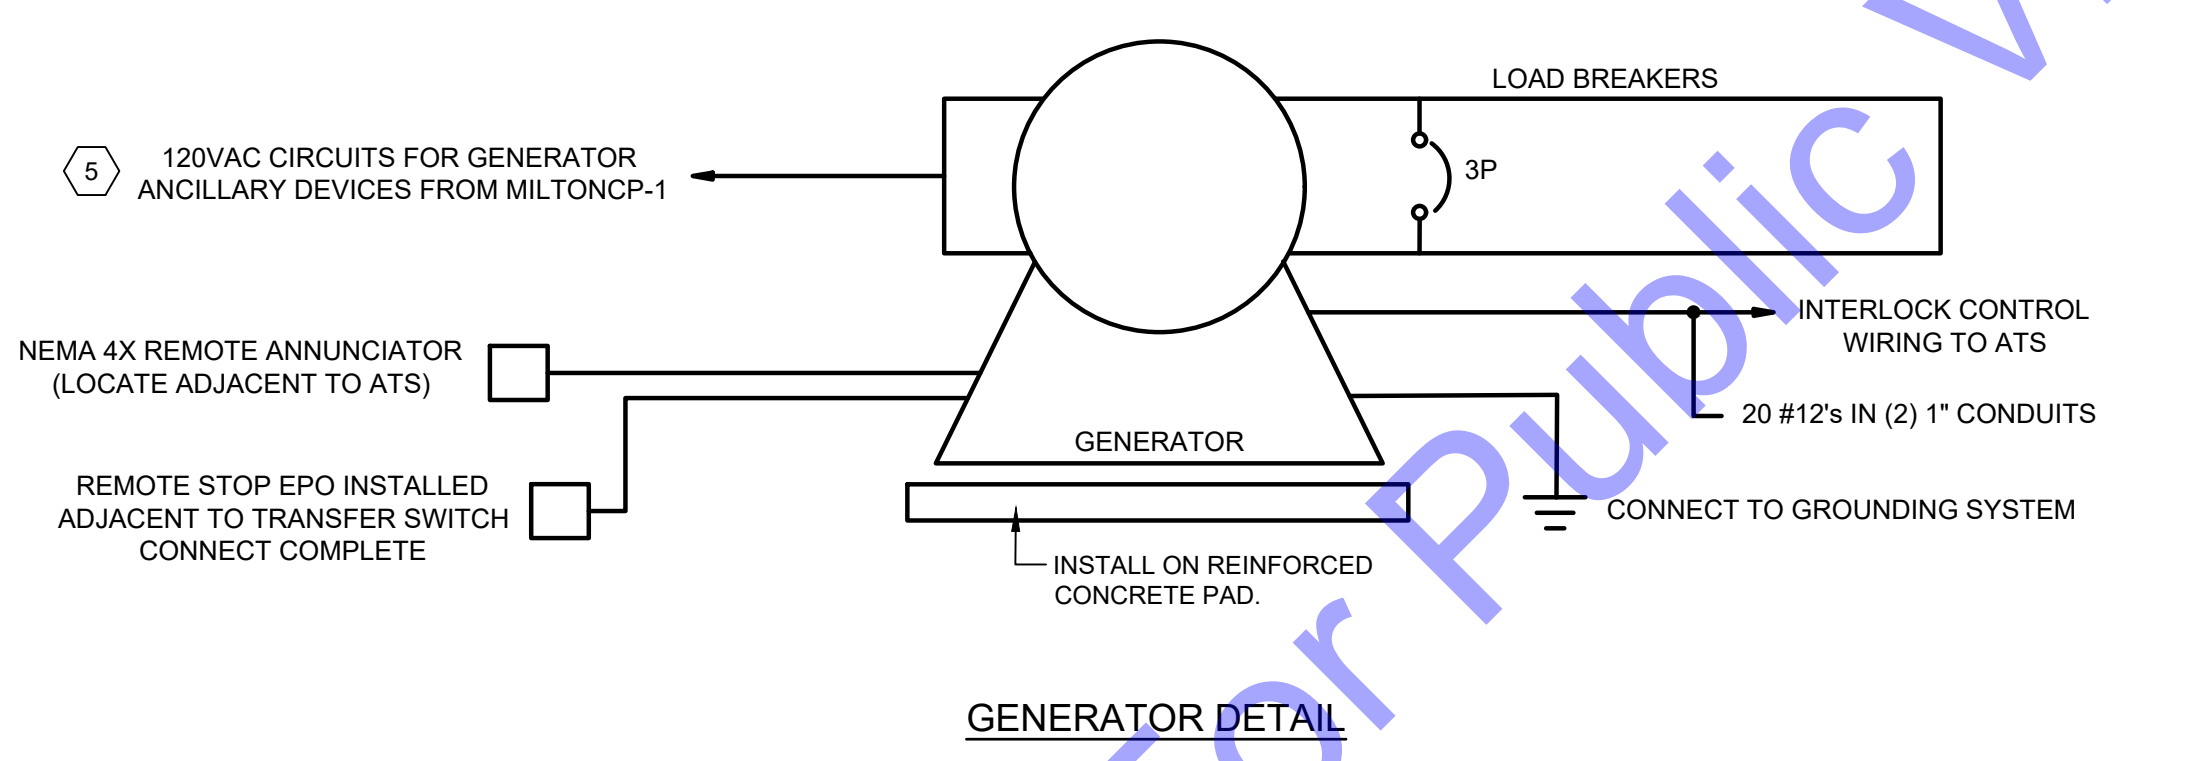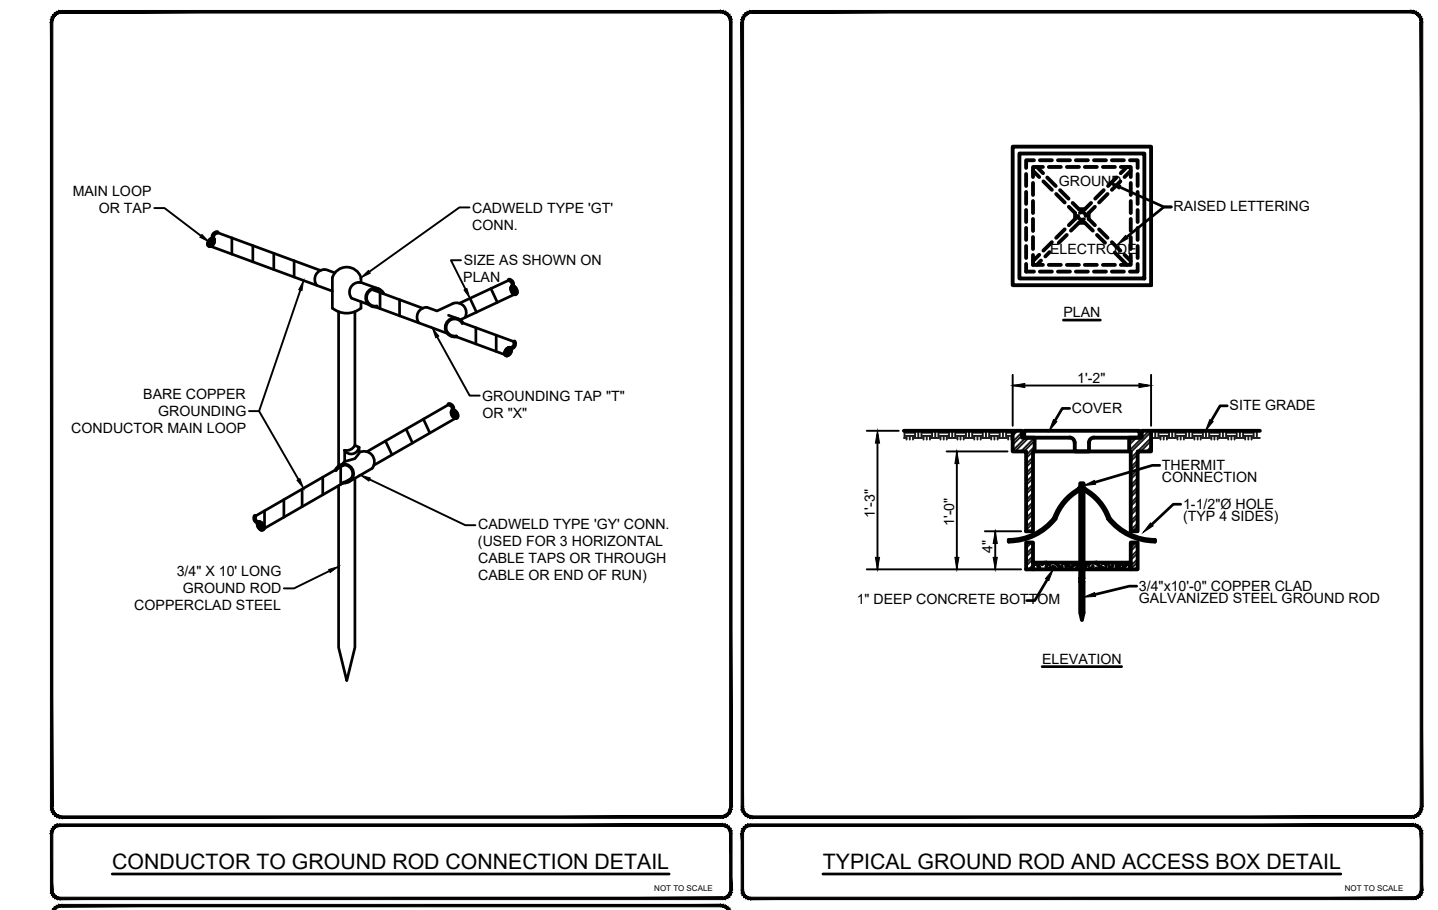

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 MARK KENNETH NORDMEYER  
 30193  
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 Signature: \_\_\_\_\_ Date: 1/13/2025

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 Issue Date: 01/2025    Project No: S24137    Scale: AS SHOWN

ELECTRICAL - MILTON LIFT STATION RISER DIAGRAM (PHASE 2)