

CITY OF ROCHESTER FULTON COUNTY, INDIANA

LEAD SERVICE LINE REPLACEMENT PROJECT - DAC AREA MARCH 2025

BOARD OF PUBLIC WORKS

TRENT ODELL.....MAYOR
GARY HARTWIG.....MEMBER
BRETT CURNUTT.....MEMBER
BETH STOCKING.....CLERK-TREASURER


CITY COUNCIL

RUTH GUNTER.....MEMBER
AMY ROE.....MEMBER
BRIAN FITZWATER.....MEMBER
MARTY SMITH.....MEMBER
JOHN GARRETT.....MEMBER
BRIAN GOODMAN.....MEMBER
BOB CANNEDY.....MEMBER


WATER BOARD

MARK SMILEY.....PRESIDENT
RACHEL STEPHEN.....MEMBER
JOHN GARRETT.....MEMBER
DERRICK HOLLOWAY.....MEMBER
CASSIE SMITH.....MEMBER

DERRICK HOLLOWAY.....WATER SUPERINTENDENT
ANDREW PERKINS.....CITY ATTORNEY

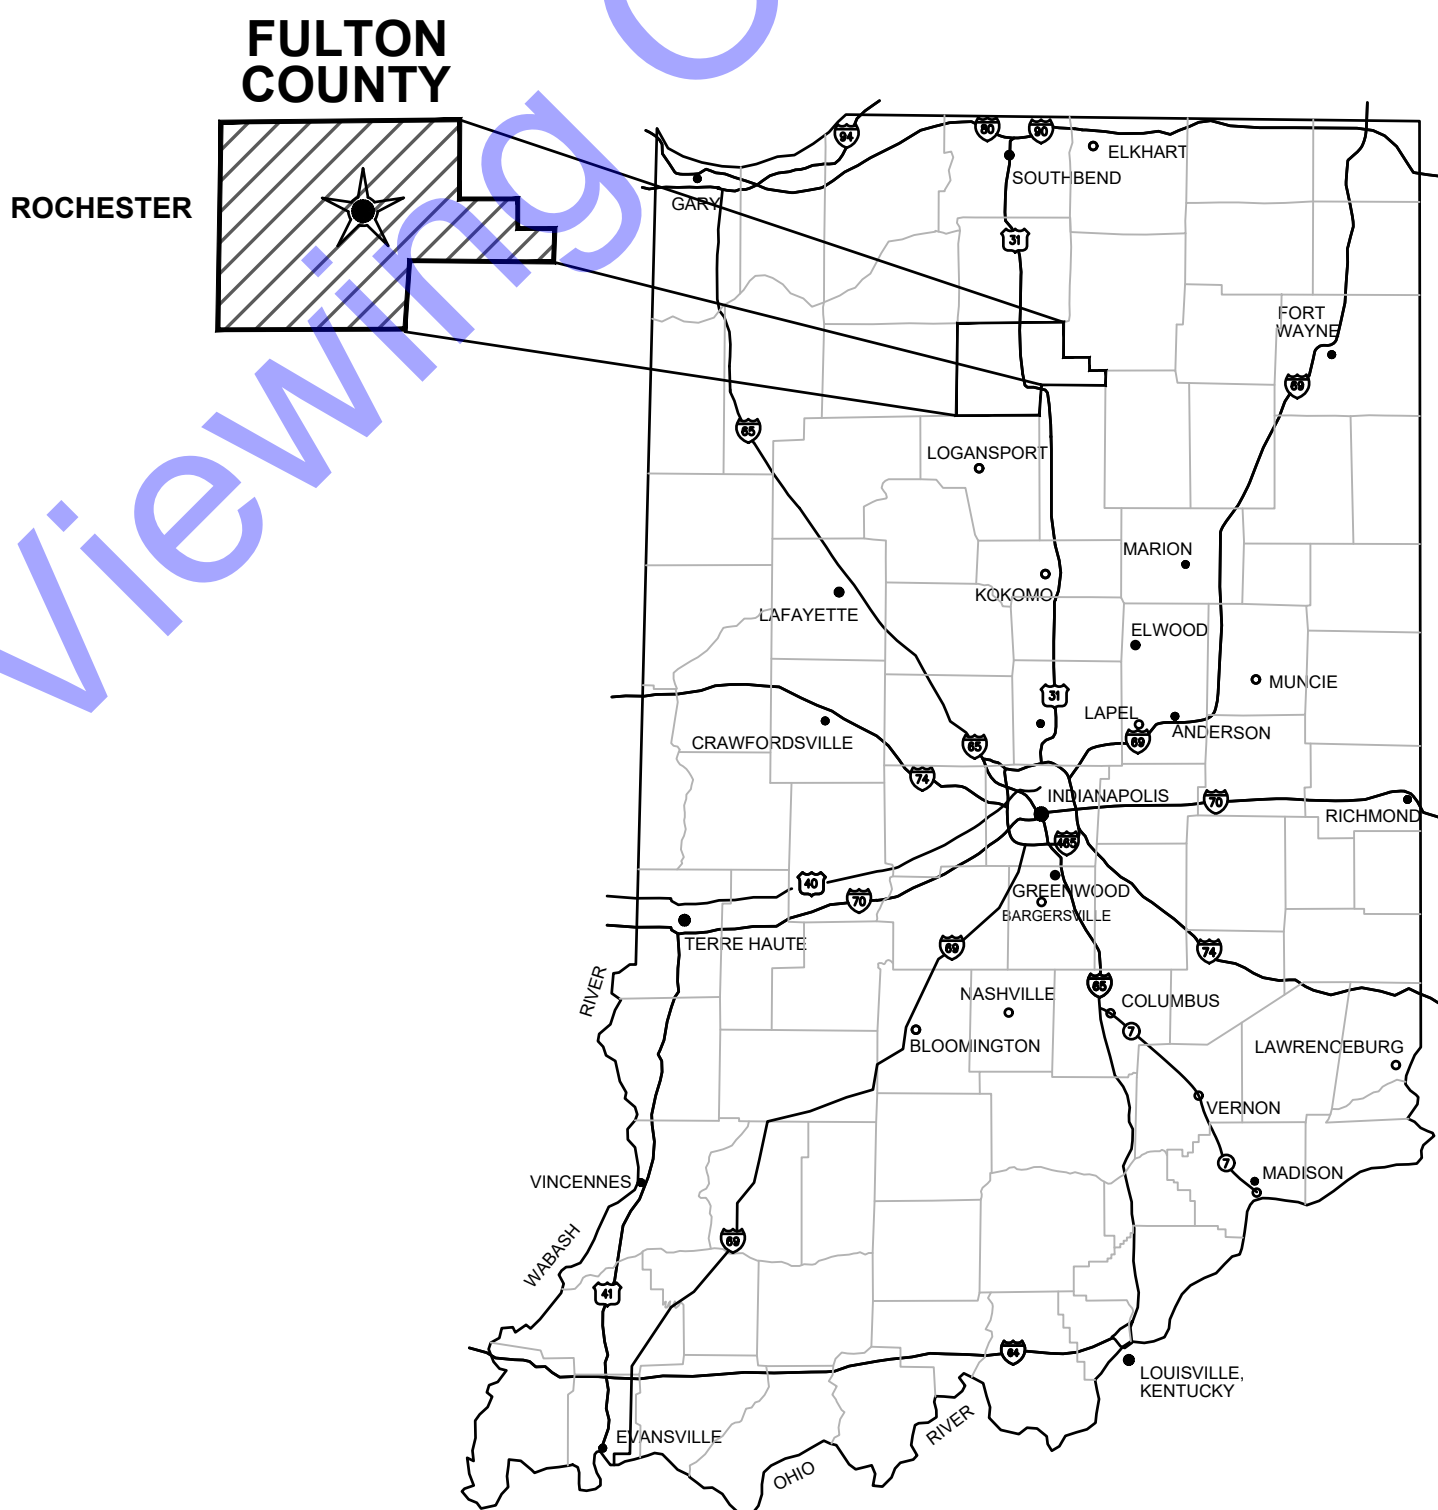


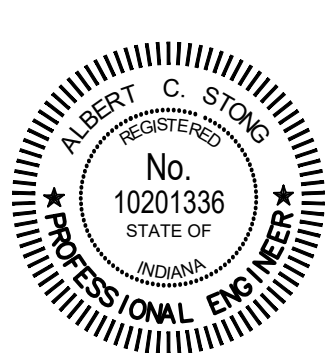
GENERAL LOCATION MAP

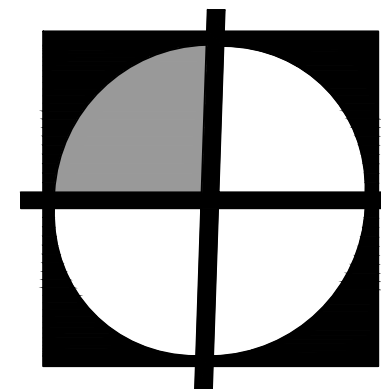


COMMONWEALTHTM
ENGINEERS, INC.
A wealth of resources to master a common goal.

QA/QC BY : JOHN WETZEL
DATE : 04/01/2025

CERTIFIED BY : 
ALBERT C. STONG
INDIANA P.E. No. 10201336
DATE : 04/01/2025



CONTRACT NO. : W24156

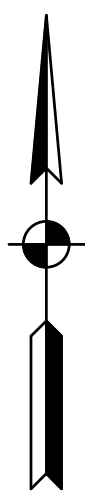

DRAWING SET INDEX

LEAD SERVICE LINE REPLACEMENT - MAIN ST DRAWINGS

LEAD SERVICE LINE REPLACEMENT - MADISON ST DRAWINGS

LEAD SERVICE LINE REPLACEMENT - MONROE ST DRAWINGS

LEAD SERVICE LINE REPLACEMENT - FRANKLIN AVE DRAWINGS

MISCELLANEOUS AND EROSION CONTROL DETAILS

MD1	MISCELLANEOUS DETAILS
MD2	MISCELLANEOUS DETAILS
EC1	EROSION CONTROL DETAILS


File: Z:\SHARED\IN CLIENTS\M-Z\ROCHESTER\DWG\LSL REPLACEMENT PROJECT\DAC AREA\06 CADIA CURRENT FILES\1 DRAWINGS\02-GENERAL DRAWINGS.DWG
 Saved: 4/2/2025 10:54:06 AM Plotted: 4/2/2025 11:01:43 AM Current User: Dylan Nagle LastSavedBy: dragle



COMMONWEALTHTM
ENGINEERS, INC.
A wealth of resources to master a complex road.

<https://commonwealthengineers.com/>

OFFICE LOCATIONS IN:
INDIANAPOLIS, IN. (2)
EVANSVILLE, IN.
FORT WAYNE, IN.
CROWN POINT, IN.
BOWLING GREEN, KY.
SOUTH BEND, IN.

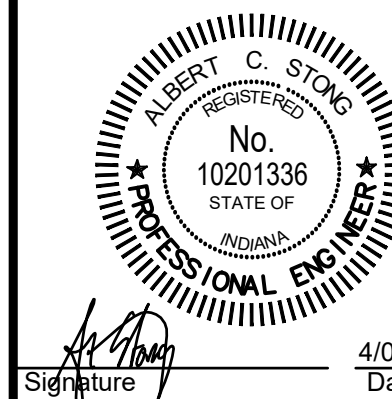

Signature

4/01/2025
Date

CITY OF ROCHESTER
FULTON COUNTY, INDIANA
LEAD SERVICE LINE
REPLACEMENT PROJECT - DAC
AREA

© 2023 BY COMMONWEALTH ENGINEERS, INC. ALL RIGHTS RESERVED. REPRODUCTION BY ANY METHOD IN WHOLE OR IN PART WITHOUT PERMISSION IS PROHIBITED



Know what's below. 811 before you dig.
1-800-382-5544
(ITS THE LAW)

[illegible]

Designed By: AL	Drawn By: SSE	Checked By: RAL
Issue Date: SUBMITTAL	Project No: W24156	Scale: AS SHOWN

VICINITY MAP AND
DRAWING SET INDEX

Drawing No:

G2

Sheet: 02 OF 86



DRAWING SET INDEX

LEAD SERVICE LINE REPLACEMENT - MAIN ST DRAWINGS

LEAD SERVICE LINE REPLACEMENT - MADISON ST DRAWINGS

LEAD SERVICE LINE REPLACEMENT - MONROE ST DRAWINGS

LEAD SERVICE LINE REPLACEMENT - FRANKLIN AVE DRAWINGS

MISCELLANEOUS AND EROSION CONTROL DETAILS

MD1	MISCELLANEOUS DETAILS
MD2	MISCELLANEOUS DETAILS
EC1	EROSION CONTROL DETAILS

GENERAL NOTES

1. ALL PROPERTY AND RIGHT-OF-WAY LINE INFORMATION SHOWN IN DRAWING SET ARE APPARENT AND SHALL NOT BE DEEMED EXACT LOCATIONS, UNLESS OTHERWISE NOTED. INFORMATION WAS OBTAINED VIA "INDIANA ON-LINE" GIS SHAPE FILES.
2. EXISTING UTILITY INFORMATION SHOWN IN DRAWING SET, MEETS "ASCE 36-02" QUALITY LEVEL **"D"**, UNLESS OTHERWISE NOTED.

UTILITY COORDINATION AND PROJECT DEPICTION OF EXISTING SUBSURFACE UTILITY DATA:

UTILITY QUALITY LEVEL DESCRIPTIONS:

UTILITY QUALITY LEVEL A - PRECISE HORIZONTAL AND VERTICAL LOCATION OF UTILITIES OBTAINED BY THE ACTUAL EXPOSURE (OR VERIFICATIONS OF PREVIOUSLY EXPOSED AND SURVEYED UTILITIES) AND SUBSEQUENT MEASUREMENT OF SUBSURFACE UTILITIES, USUALLY AT A SPECIFIC POINT. ACCURACY OF LOCATION MATCHES PROJECT SURVEY TOLERANCE.



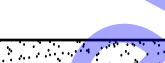





UTILITY QUALITY LEVEL B - INFORMATION OBTAINED THROUGH THE APPLICATION OF APPROPRIATE SURFACE GEOPHYSICAL METHODS TO DETERMINE THE EXISTENCE AND APPROXIMATE HORIZONTAL POSITION SUBSURFACE UTILITIES. THE RELIABILITY OF THIS INFORMATION IS SURVEYED TO PROJECT CONTROL AND SUBJECT TO ACCURACY LEVELS OF THE GEOPHYSICAL TOLERANCE DEFINED BY THE PROJECT.

UTILITY QUALITY LEVEL C - INFORMATION OBTAINED BY SURVEYING AND PLOTTING VISIBLE ABOVE GROUND UTILITY FEATURES AND CORRELATING QUALITY LEVEL "D" INFORMATION.



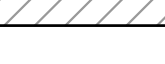

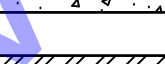

















UTILITY QUALITY LEVEL D - INFORMATION DERIVED FROM EXISTING RECORDS OR VERBAL RECOLLECTIONS.
3. NORTHING AND EASTING COORDINATES SHOWN ON ALL MANHOLE, INLETS, ETC. ARE SHOWN FROM CENTER OF STRUCTURE NOT CASTING, UNLESS OTHERWISE NOTED.
4. ALL MANHOLES THAT HAVE PIPE INVERT DIFFERENTIAL OF 2' OR GREATER, SHALL BE CONSIDERED A DROP MANHOLE. CONTRACTOR SHALL REFER TO MISCELLANEOUS DETAILS AND DETAILED SPECIFICATIONS FOR MORE INFORMATION.











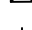


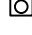




















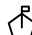



















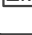



1. CONTRACTOR TO AVOID/PROTECT ANY EXISTING MANHOLES, SEWER, OR CULVERTS. IF DISTURBED OR DAMAGED, CONTRACTOR TO REPLACE CONDITIONS EQUAL TO OR BETTER THAN EXISTING.
2. SANITARY LATERAL LOCATIONS ARE UNKNOWN. CONTRACTOR TO FIELD VERIFY LOCATION AND DEPTH OF EXISTING SANITARY LATERALS PRIOR TO THE INSTALLATION OF NEW WATER SERVICES.
3. CONTRACTOR TO FIELD VERIFY THE LOCATION AND DEPTHS OF ALL EXISTING UTILITIES PRIOR TO CONSTRUCTION. IF UTILITY CONFLICTS OCCUR, CONTRACTOR SHALL NOTIFY RPR PRIOR TO PROCEEDING WITH WORK. ROUTE OF NEW WATER SERVICE MAY BE MODIFIED IN THE FIELD TO AVOID CONFLICTS WITH OTHER UTILITIES.
4. ALL WATER UTILITY CUSTOMERS SHALL BE GIVEN 48 HOURS NOTICE PRIOR TO THE TEMPORARY INTERRUPTIONS OF SERVICE TO ACCOMMODATE THE TRANSFER OF WATER SERVICE TO THE NEW WATER SERVICE LINE. NO CUSTOMERS SHALL BE WITHOUT WATER FOR LONGER THAN 4 HOURS.
5. NEW SERVICES SHALL BE REPLACED FULLY FROM THE WATER MAIN TO THE SHUTOFF VALVE INSIDE THE HOME (PREMISE PLUMBING), WHERE THE NEW SHUTOFF VALVE IS NOT READILY ACCESSIBLE WITHIN THE HOME, A NEW SHUTOFF VALVE SHALL BE INSTALLED JUST INSIDE THE HOME.
6. ALL NEW CURB STOPS AND METER PITS SHALL BE LOCATED WITHIN THE RIGHT OF WAY. ROUTE OF THE NEW WATER SERVICE MAY BE MODIFIED IN THE FIELD TO MINIMIZE DISTURBANCES TO EXISTING LANDSCAPING OR OTHER SURFACE ITEMS, PROVIDED REVIEW AND ACCEPTANCE BY THE OWNER (CITY).
7. CONTRACTOR TO USE A LICENSED PLUMBER FOR MAKING THE IN-HOUSE SERVICE CONNECTION.
8. CONTRACTOR SHALL PLAN CONSTRUCTION ACTIVITIES TO MINIMIZE IMPACT TO LOCAL TRAFFIC. LOCAL TRAFFIC ACCESS, INCLUDING ACCESS TO ALL RESIDENCES AND EMERGENCY VEHICLES MUST BE MAINTAINED AT ALL TIMES. SUCH TRAFFIC CONTROL DEVICES SHALL COMPLY WITH THE LATEST EDITION OF THE MUTCD AND ALL APPLICABLE INDIANA SUPPLEMENTS.
9. CONTRACTOR SHALL PROVIDE ADDITIONAL EROSION CONTROL MEASURES AS SPECIFIED IN THE DETAILED SPECIFICATIONS, INCLUDING BUT NOT LIMITED TO CONCRETE WASH OUT STATIONS, TEMPORARY CONSTRUCTION ENTRANCES, TEMPORARY SEEDING, ETC. AS REQUIRED DURING THE DURATION OF THE PROJECT TO MAINTAIN COMPLIANCE WITH THE RULE 5 PERMIT. CONTRACTOR SHALL ADHERE TO ALL REQUIREMENTS OF RULE 5 PERMIT, INCLUDING PROVIDING REQUIRED NOTIFICATIONS TO THE REQUIRED AGENCIES.


HATCHING SYMBOLS

	- CMU WALL (PLAN VIEW)
	- GRANULAR BACKFILL (PROFILE VIEW)
	- DEMOLITION (CONTRACTOR SHALL REFER TO DETAILED SPECIFICATIONS)
	- GROUT
	- CONCRETE
	- STEEL
	- COMPACTED GRANULAR BACKFILL OR COMPACTED FOUNDATION
	- ABANDONED IN PLACE

	TELEPHONE MANHOLE
	TELEPHONE LINE MARKER
	TRAFFIC MANHOLE
	WATER LINE MARKER
	METER PIT
	VALVE
	IRRIGATION CONTROL VALVE
	FIRE HYDRANT
	FLUSH HYDRANT
	YARD HYDRANT
	WALL SPIGOT
	EXISTING PIPE PLUG
	STORM CATCH BASIN (SQUARE)
	STORM CATCH BASIN (ROUND)
	STORM CURB INLET
	STORM MANHOLE
	SANITARY MANHOLE
	SANITARY VALVE
	CLEANOUT
	VENT
	NEW VALVE
	NEW FIRE HYDRANT
	NEW FLUSH HYDRANT
	NEW WET SADDLE AND VALVE BODY
	NEW PLUG
	NEW LINE STOP
	NEW CUT AND CAP
	NEW SANITARY MH
	NEW METER PIT
	NEW CURB STOP

	EXISTING OVERHEAD TELEPHONE LINE
	EXISTING GAS LINE AND VALVE
	EXISTING WATER LINE AND VALVE
	EXISTING FIBER OPTIC LINE
	EXISTING OVERHEAD ELECTRIC LINE
	EXISTING BURIED ELECTRIC
	EXISTING NON-POTABLE WATER LINE
	EXISTING POTABLE WATER LINE
	EXISTING BURIED TELEPHONE LINE
	EXISTING FENCE
	APPARENT EXISTING FIBER OPTIC LINE
	APPARENT EXISTING GAS LINE AND VALVE
	APPARENT EXISTING ELECTRIC
	APPARENT RIGHT-OF-WAY
	APPARENT PROPERTY LINE
	EDGE OF ROAD
	EDGE OF ROAD WITH CURB
	EXISTING MAJOR CONTOUR LINE
	EXISTING MINOR CONTOUR LINE
	NEW WATER LINE
	PROPOSED MAJOR CONTOUR LINE
	PROPOSED MINOR CONTOUR LINE

	AC UNIT		TELEPHONE LINE MARKER
	BOLLARD		TRAFFIC MANHOLE
	Boulder / LARGE ROCK		WATER LINE MARKER
	CENTER LINE MONUMENT		METER PIT
	ROW MONUMENT		VALVE
	CONTROL POINT / BENCH MARK		IRRIGATION CONTROL VALVE
	CURB STOP		FIRE HYDRANT
	MAIL BOX		FLUSH HYDRANT
	FLAG POLE		YARD HYDRANT
	POST		WALL SPIGOT
	STUMP		EXISTING PIPE PLUG
	BUSH / HEDGE		STORM CATCH BASIN (SQUARE)
	DECIDUOUS TREE		STORM CATCH BASIN (ROUND)
	CONIFEROUS TREE		STORM CURB INLET
	SIGN		STORM MANHOLE
	UTILITY LOCATE FLAG		SANITARY MANHOLE
	GAS LINE MARKER		SANITARY VALVE
	GAS VALVE		CLEANOUT
	GAS METER		VENT
	GUY POLE		NEW VALVE
	POWER POLE		NEW FIRE HYDRANT
	LIGHT POLE		NEW FLUSH HYDRANT
	GUY WIRE		NEW WET SADDLE AND VALVE
	ELECTRIC METER		NEW PLUG
	ELECTRIC PANEL		NEW LINE STOP
	ELECTRIC TRANSFORMER		NEW CUT AND CAP
	HAND HOLE BOX		NEW SANITARY MH
	FIBER OPTIC MARKER		NEW METER PIT
	TEL/TV PEDESTAL		NEW CURB STOP



ALBERT C. STONG
REGISTERED
No.
10201336
STATE OF
INDIANA
PROFESSIONAL ENGINEER

Signature _____ Date 4/01/2025

**CITY OF ROCHESTER
FULTON COUNTY, INDIANA
LEAD SERVICE LINE
REPLACEMENT PROJECT - DAC
AREA**


© 2023 BY COMMONWEALTH ENGINEERS, INC. ALL RIGHTS RESERVED. REPRODUCTION BY ANY METHOD IN WHOLE OR IN PART WITHOUT PERMISSION IS PROHIBITED

[illegible]

Designed By: AL	Drawn By: SSE	Checked By: RAL
Issue Date: SUBMITTAL	Project No: W24156	Scale: AS SHOWN

GENERAL ABBREVIATIONS, LEGENDS, SYMBOLS, AND NOTES

Drawing No:
G3
Sheet: 03 OF 86

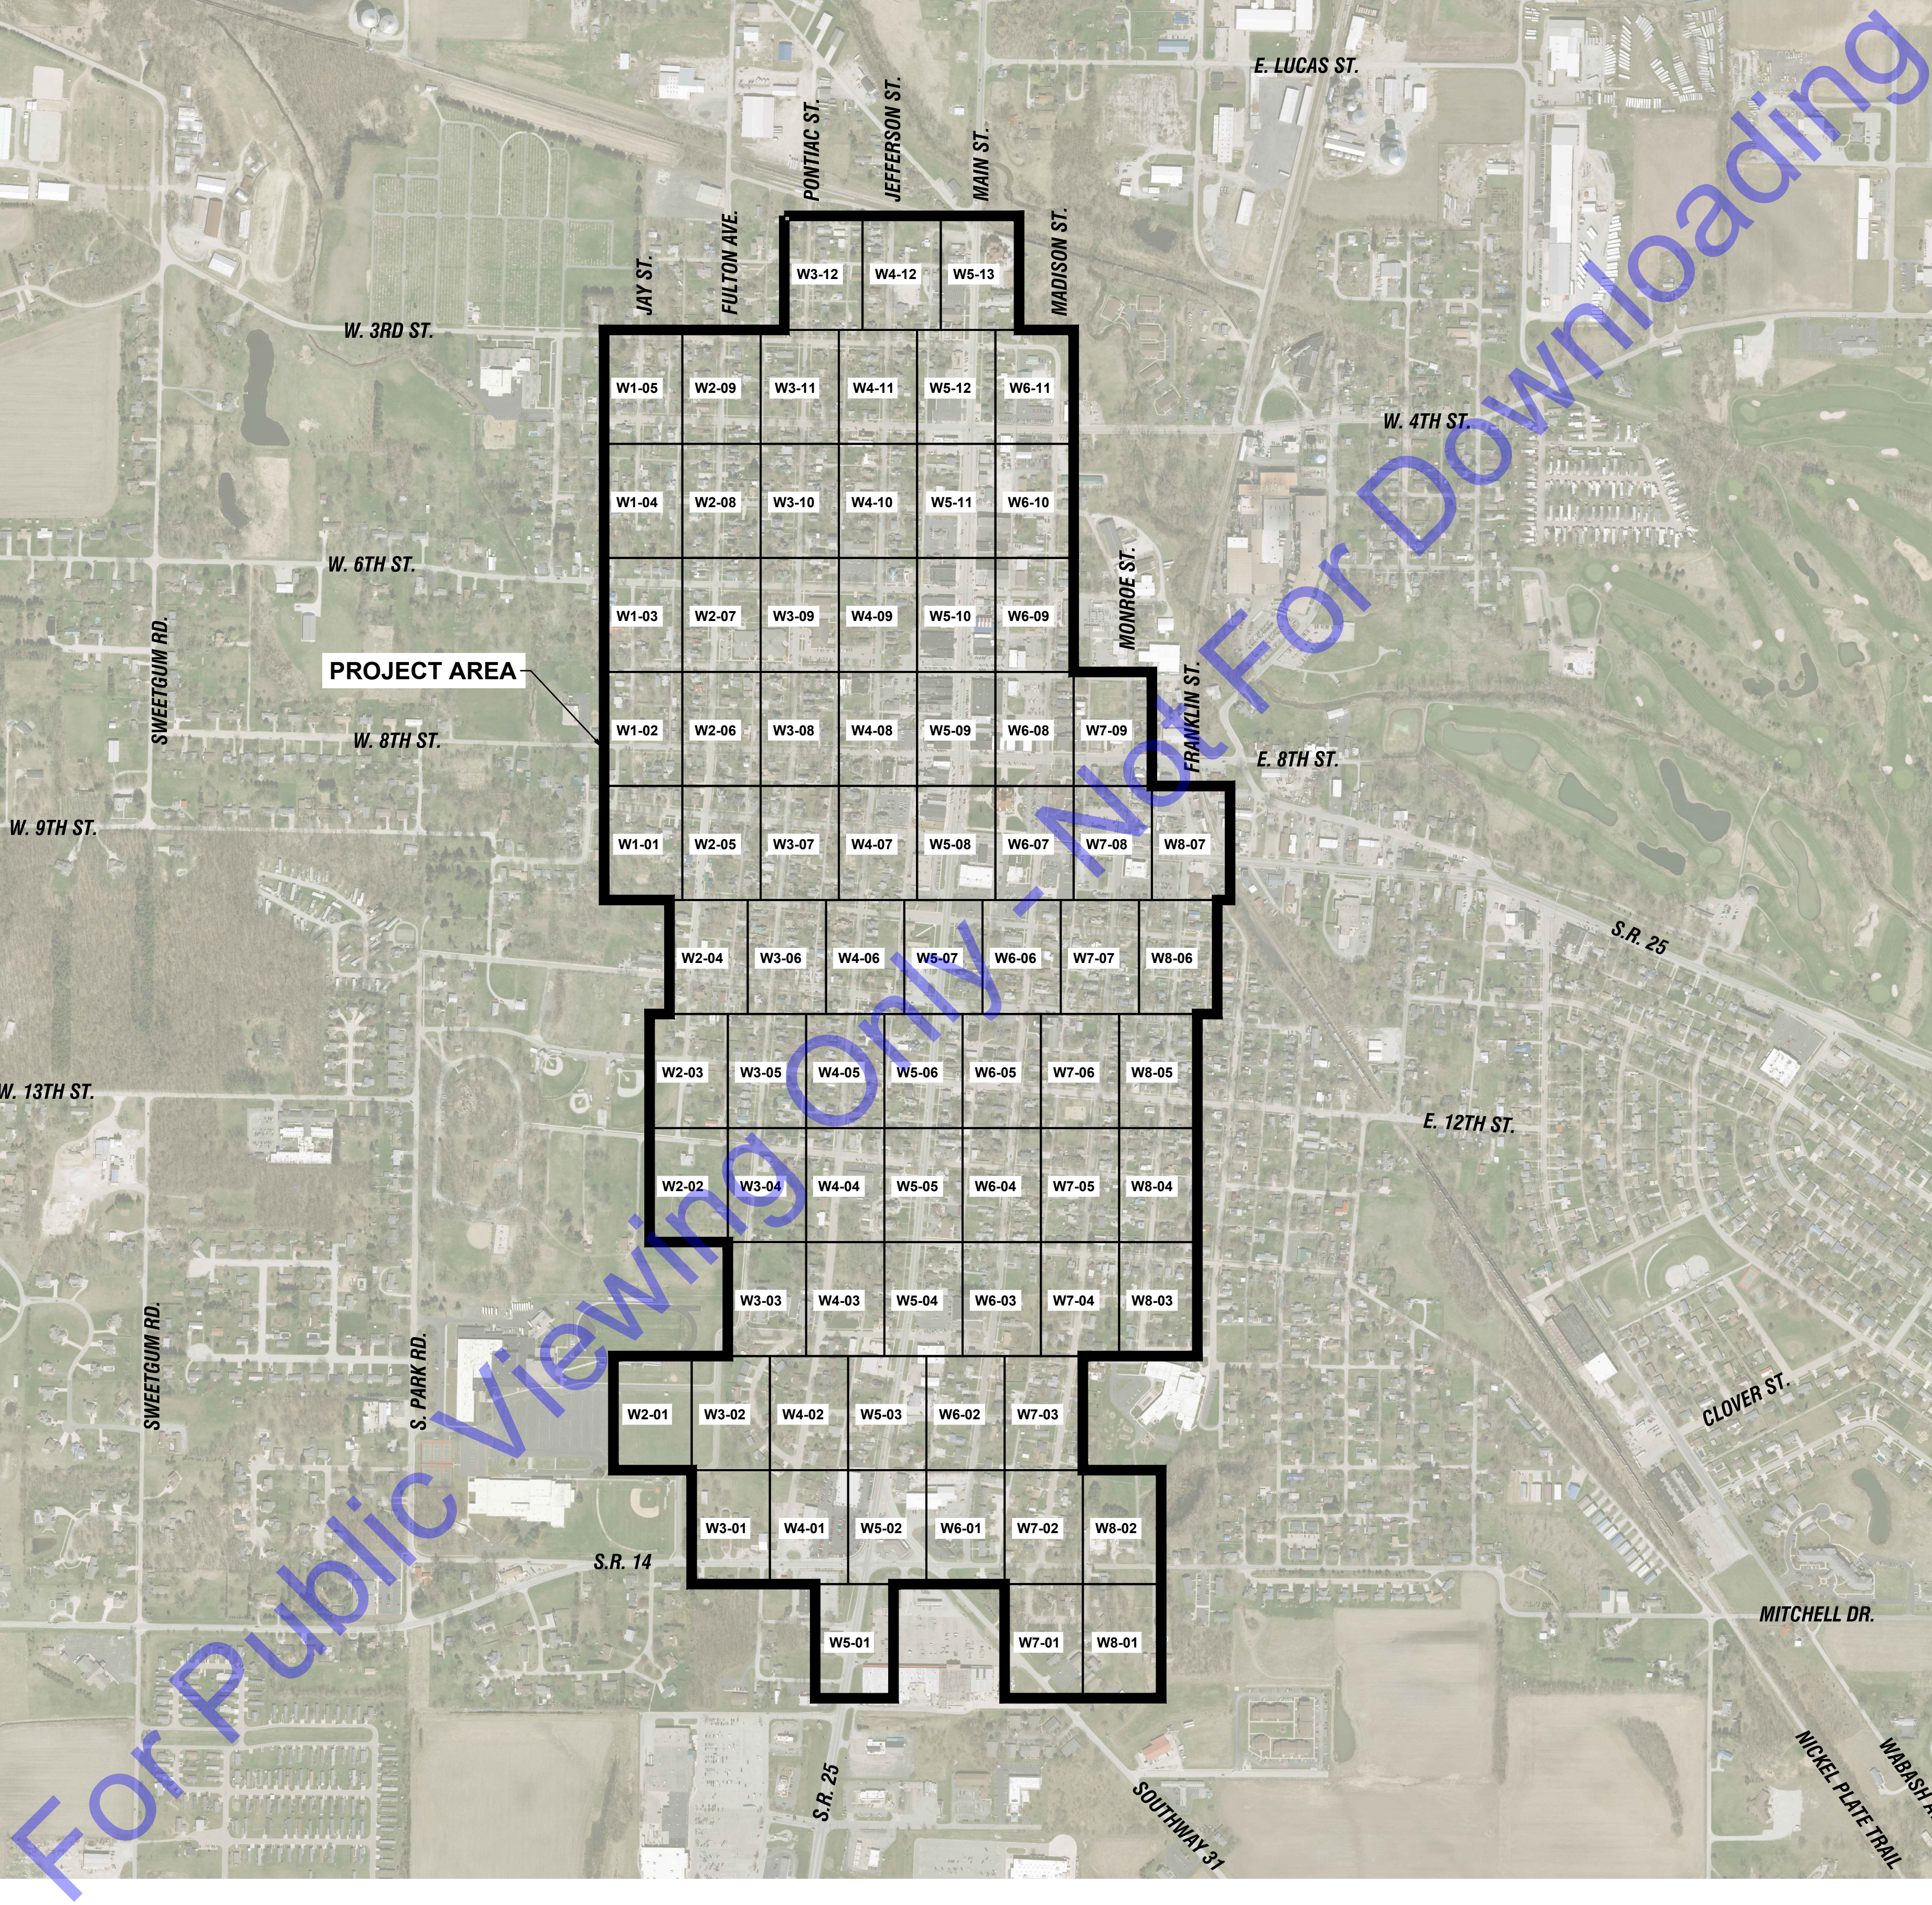


SCALE: 1"=500'-0"

0 500' 1,000'

A horizontal graphic scale bar with alternating black and white segments. It is marked with '0' at the left end, '500'' in the middle, and '1,000'' at the right end.


<https://commonwealthengineers.com/>

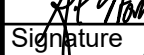

4/01/2025
Date

CITY OF ROCHESTER
FULTON COUNTY, INDIANA
LEAD SERVICE LINE
REPLACEMENT PROJECT - DRAINAGE
AREA

© 2023 BY COMMONWEALTH
ENGINEERS, INC. ALL RIGHTS
RESERVED. REPRODUCTION
BY ANY METHOD IN WHOLE
OR IN PART WITHOUT
PERMISSION IS PROHIBITED

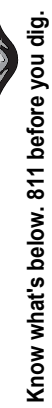[illegible]

Designed By: AL	Drawn By: SSE	Checked By: RAL
Issue Date: SUBMITTAL	Project No: W24156	Scale: AS SHOWN

DRAWING INDEX MAP

G4

Sheet: 04 OF 86

- ① CONTRACTOR SHALL VERIFY THE EXISTING SERVICE LINE MATERIAL TO BE EITHER LEAD OR GALVANIZED PRIOR TO REPLACING THE SERVICE LINE. CONTRACTOR SHALL POTHOLE THE CITY-OWNED SIDE OF THE SERVICE LINE A MINIMUM OF 3 FT BACK FROM CURB STOP.
- ② NEW 1" WATER SERVICE AND CURB STOP OR METER PIT
- ③ NEW 1-1/2" WATER SERVICE AND CURB STOP OR METER PIT
- ④ CURB STOP AND/OR METER PIT IS SHOWN FOR REPLACEMENT AND COULD NOT BE LOCATED IN THE FIELD. CONTRACTOR SHALL LOCATE PRIOR TO REPLACEMENT.
- ⑤ CONTRACTOR SHALL DISCONNECT EXISTING SERVICE LINE AT WATER MAIN AND ABANDON. EXISTING SERVICE LINE SHALL BE CUT AND CRIMPED. SERVICE LINE SHALL NOT BE REPLACED SINCE LOT IS EMPTY.



SCALE: 1"=20'-0"

0 20' 40'

A horizontal scale bar with alternating black and white segments. It is marked with '0' at the left end, '20'' at the midpoint, and '40'' at the right end.

FOR CONTINUATION SEE DWG W1-02



ALBERT C. STONG
REGISTERED
No.
10201336
STATE OF
INDIANA
PROFESSIONAL ENGINEER

signature _____ 4/01/11
Date _____

**CITY OF ROCHESTER
FULTON COUNTY, INDIANA
LEAD SERVICE LINE
REPLACEMENT PROJECT - DAC
AREA**

© 2023 BY COMMONWEALTH
ENGINEERS, INC. ALL RIGHTS
RESERVED. REPRODUCTION
BY ANY METHOD IN WHOLE
OR IN PART WITHOUT
PERMISSION IS PROHIBITED



Know what's below. 811 before you dig.
1-800-382-5544
(ITS THE LAW)

[illegible]

Designed By: AL	Drawn By: SSE	Checked By: RAL
Issue Date: SUBMITTAL	Project No: W24156	Scale: AS SHOWN

PLAN VIEW

Drawing No:

W1-01

Sheet: 05 OF 86


FOR CONTINUATION SEE DWG W1-01



FOR CONTINUATION SEE DWG W2-06

PLAN VIEW

SCALE: 1"=20'-0"

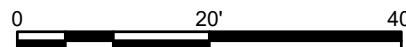

PROPOSED PLAN NOTES:

- ① CONTRACTOR SHALL VERIFY THE EXISTING SERVICE LINE MATERIAL TO BE EITHER LEAD OR GALVANIZED PRIOR TO REPLACING THE SERVICE LINE. CONTRACTOR SHALL POTHOLE THE CITY-OWNED SIDE OF THE SERVICE LINE A MINIMUM OF 3 FT BACK FROM CURB STOP.
- ② NEW 1" WATER SERVICE AND CURB STOP OR METER PIT
- ③ NEW 1-1/2" WATER SERVICE AND CURB STOP OR METER PIT
- ④ CURB STOP AND/OR METER PIT IS SHOWN FOR REPLACEMENT AND COULD NOT BE LOCATED IN THE FIELD. CONTRACTOR SHALL LOCATE PRIOR TO REPLACEMENT.
- ⑤ CONTRACTOR SHALL DISCONNECT EXISTING SERVICE LINE AT WATER MAIN AND ABANDON. EXISTING SERVICE LINE SHALL BE CUT AND CRIMPED. SERVICE LINE SHALL NOT BE REPLACED SINCE LOT IS EMPTY.

© 2023 BY COMMONWEALTH ENGINEERS, INC. ALL RIGHTS RESERVED. REPRODUCTION BY ANY METHOD IN WHOLE OR IN PART WITHOUT PERMISSION IS PROHIBITED

[illegible]

Designed By: AL	Drawn By: SSE	Checked By: RAL
Issue Date: SUBMITTAL	Project No: W24156	Scale: AS SHOWN

PLAN VIEW

Drawing No:

W1-02


Sheet: 06 OF 86



COMMONWEALTHTM
ENGINEERS, INC.
A wealth of resources to master a common goal.

<https://commonwealthengineers.com/>

OFFICE LOCATIONS IN:
INDIANAPOLIS, IN. (2)
EVANSVILLE, IN.
FORT WAYNE, IN.
CROWN POINT, IN.
BOWLING GREEN, KY.
SOUTH BEND, IN.

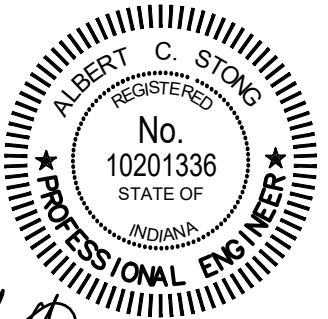

Signature

4/01/2025
Date


**CITY OF ROCHESTER
FULTON COUNTY, INDIANA
LEAD SERVICE LINE
REPLACEMENT PROJECT - DAC
AREA**



FOR CONTINUATION SEE DWG W2-07

PLAN VIEW

SCALE: 1"=20'-0"

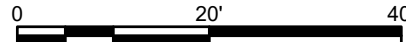


PROPOSED PLAN NOTES:

- 1 CONTRACTOR SHALL VERIFY THE EXISTING SERVICE LINE MATERIAL TO BE EITHER LEAD OR GALVANIZED PRIOR TO REPLACING THE SERVICE LINE. CONTRACTOR SHALL POTHOLE THE CITY-OWNED SIDE OF THE SERVICE LINE A MINIMUM OF 3 FT BACK FROM CURB STOP.
- 2 NEW 1" WATER SERVICE AND CURB STOP OR METER PIT
- 3 NEW 1-1/2" WATER SERVICE AND CURB STOP OR METER PIT
- 4 CURB STOP AND/OR METER PIT IS SHOWN FOR REPLACEMENT AND COULD NOT BE LOCATED IN THE FIELD. CONTRACTOR SHALL LOCATE PRIOR TO REPLACEMENT.
- 5 CONTRACTOR SHALL DISCONNECT EXISTING SERVICE LINE AT WATER MAIN AND ABANDON. EXISTING SERVICE LINE SHALL BE CUT AND CRIMPED. SERVICE LINE SHALL NOT BE REPLACED SINCE LOT IS EMPTY.



OFFICE LOCATIONS IN:
INDIANAPOLIS, IN (2)
EVANSVILLE, IN
FORT WAYNE, IN
CROWN POINT, IN
BOWLING GREEN, KY
SOUTH BEND, IN

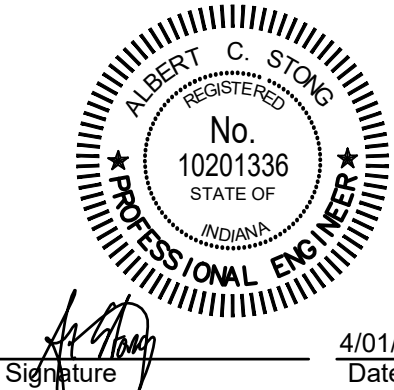

Signature: [Signature] Date: 4/01/2025

CITY OF ROCHESTER
FULTON COUNTY, INDIANA
LEAD SERVICE LINE
REPLACEMENT PROJECT - DAC
AREA

© 2023 BY COMMONWEALTH ENGINEERS, INC. ALL RIGHTS RESERVED. REPRODUCTION BY ANY METHOD IN WHOLE OR IN PART WITHOUT PERMISSION IS PROHIBITED.
Indiana 811
Know what's below. 811 before you dig.
1-800-382-5544
(IT'S THE LAW)

No.	Submittal / Revision	By	Date

Designed By: AL	Drawn By: SSE	Checked By: RAL
Issue Date: SUBMITTAL	Project No: W24156	Scale: AS SHOWN

PLAN VIEW

Drawing No:

W1-03

Sheet: 07 OF 86


FOR CONTINUATION SEE DWG W1-03



FOR CONTINUATION SEE DWG W2-08

PLAN VIEW

SCALE: 1"=20'-0"

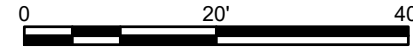

PROPOSED PLAN NOTES:

- ① CONTRACTOR SHALL VERIFY THE EXISTING SERVICE LINE MATERIAL TO BE EITHER LEAD OR GALVANIZED PRIOR TO REPLACING THE SERVICE LINE. CONTRACTOR SHALL POTHOLE THE CITY-OWNED SIDE OF THE SERVICE LINE A MINIMUM OF 3 FT BACK FROM CURB STOP.
- ② NEW 1" WATER SERVICE AND CURB STOP OR METER PIT
- ③ NEW 1-1/2" WATER SERVICE AND CURB STOP OR METER PIT
- ④ CURB STOP AND/OR METER PIT IS SHOWN FOR REPLACEMENT AND COULD NOT BE LOCATED IN THE FIELD. CONTRACTOR SHALL LOCATE PRIOR TO REPLACEMENT.
- ⑤ CONTRACTOR SHALL DISCONNECT EXISTING SERVICE LINE AT WATER MAIN AND ABANDON. EXISTING SERVICE LINE SHALL BE CUT AND CRIMPED. SERVICE LINE SHALL NOT BE REPLACED SINCE LOT IS EMPTY.

**CITY OF ROCHESTER
FULTON COUNTY, INDIANA
LEAD SERVICE LINE
REPLACEMENT PROJECT - DAC
AREA**

© 2023 BY COMMONWEALTH ENGINEERS, INC. ALL RIGHTS RESERVED. REPRODUCTION BY ANY METHOD IN WHOLE OR IN PART WITHOUT PERMISSION IS PROHIBITED


Indiana 811
Know what's below. 811 before you dig.



COMMONWEALTHTM
ENGINEERS, INC.

A wealth of resources to master a common goal.

OFFICE LOCATIONS IN:
INDIANAPOLIS, IN. (2)
EVANSVILLE, IN.
FORT WAYNE, IN.
CROWN POINT, IN.
BOWLING GREEN, KY.
SOUTH BEND, IN.



ALBERT C. STONG
REGISTERED
No.
10201336
STATE OF
INDIANA
PROFESSIONAL ENGINEER

Albert C. Stong
Signature

4/01
Date

Signature _____ Date 4/01/2025

[illegible]

Designed By: AL	Drawn By: SSE	Checked By: RAL
--------------------	------------------	--------------------

Issue Date:	Project No:	Scale:
SUBMITTAL	W24156	AS SHOWN

LAN VIEW

Drawing No:

V1-04


Sheet: 08 OF 86



FOR CONTINUATION SEE DWG W2-09

PLAN VIEW

SCALE: 1"=20'-0"

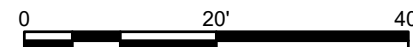

PROPOSED PLAN NOTES:

- ① CONTRACTOR SHALL VERIFY THE EXISTING SERVICE LINE MATERIAL TO BE EITHER LEAD OR GALVANIZED PRIOR TO REPLACING THE SERVICE LINE. CONTRACTOR SHALL POTHOLE THE CITY-OWNED SIDE OF THE SERVICE LINE A MINIMUM OF 3 FT BACK FROM CURB STOP.
- ② NEW 1" WATER SERVICE AND CURB STOP OR METER PIT
- ③ NEW 1-1/2" WATER SERVICE AND CURB STOP OR METER PIT
- ④ CURB STOP AND/OR METER PIT IS SHOWN FOR REPLACEMENT AND COULD NOT BE LOCATED IN THE FIELD. CONTRACTOR SHALL LOCATE PRIOR TO REPLACEMENT.
- ⑤ CONTRACTOR SHALL DISCONNECT EXISTING SERVICE LINE AT WATER MAIN AND ABANDON. EXISTING SERVICE LINE SHALL BE CUT AND CRIMPED. SERVICE LINE SHALL NOT BE REPLACED SINCE LOT IS EMPTY.

**CITY OF ROCHESTER
FULTON COUNTY, INDIANA
LEAD SERVICE LINE
REPLACEMENT PROJECT - DAC
AREA**

© 2023 BY COMMONWEALTH ENGINEERS, INC. ALL RIGHTS RESERVED. REPRODUCTION BY ANY METHOD IN WHOLE OR IN PART WITHOUT PERMISSION IS PROHIBITED

Indiana811

Know what's below. 811 before you dig.
1-800-382-5544
(ITS THE LAW)

[illegible]

Designed By: AL	Drawn By: SSE	Checked By: RAL
Issue Date: SUBMITTAL	Project No: W24156	Scale: AS SHOWN

PLAN VIEW

Drawing No:

W1-05


Sheet: 09 OF 86



COMMONWEALTHTM
ENGINEERS, INC.
A wealth of resources to meet a common goal.

<https://commonwealthengineers.com/>

OFFICE LOCATIONS IN:
INDIANAPOLIS, IN. (2)
EVANSVILLE, IN.
FORT WAYNE, IN.
CROWN POINT, IN.
BOWLING GREEN, KY.
SOUTH BEND, IN.

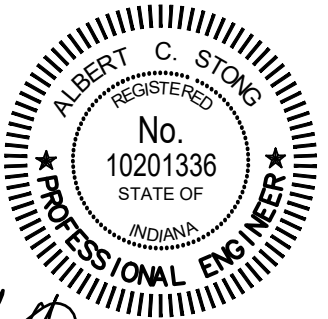

Signature

4/01/2025
Date



FOR CONTINUATION SEE DWG W3-01

PLAN VIEW

SCALE: 1"=20'-0"



0 20' 40'

A horizontal scale bar with alternating black and white segments. It is marked with '0' at the left end, '20'' at the midpoint, and '40'' at the right end.

- PROPOSED PLAN NOTES:**

- 1 CONTRACTOR SHALL VERIFY THE EXISTING SERVICE LINE MATERIAL TO BE EITHER LEAD OR GALVANIZED PRIOR TO REPLACING THE SERVICE LINE. CONTRACTOR SHALL POTHOLE THE CITY-OWNED SIDE OF THE SERVICE LINE A MINIMUM OF 3 FT BACK FROM CURB STOP.
- 2 NEW 1" WATER SERVICE AND CURB STOP OR METER PIT
- 3 NEW 1-1/2" WATER SERVICE AND CURB STOP OR METER PIT
- 4 CURB STOP AND/OR METER PIT IS SHOWN FOR REPLACEMENT AND COULD NOT BE LOCATED IN THE FIELD. CONTRACTOR SHALL LOCATE PRIOR TO REPLACEMENT.
- 5 CONTRACTOR SHALL DISCONNECT EXISTING SERVICE LINE AT WATER MAIN AND ABANDON. EXISTING SERVICE LINE SHALL BE CUT AND CRIMPED. SERVICE LINE SHALL NOT BE REPLACED SINCE LOT IS EMPTY.

FOR CONTINUATION SEE DWG W2-02

<div style="text-align: center; font-weight: bold; margin-bottom: 5px;">COMMONWEALTH ENGINEERS, INC.</div> <p>A member of members to provide a customer good</p>  https://commonwealthengineers.com/	OFFICE LOCATIONS IN: INDIANAPOLIS, IN. (2) EVANSVILLE, IN. FORT WAYNE, IN. CROWN POINT, IN. BOWLING GREEN, KY. SOUTH BEND, IN.		
Signature _____ Date 4/01/2025			
CITY OF ROCHESTER FULTON COUNTY, INDIANA LEAD SERVICE LINE REPLACEMENT PROJECT - DAC AREA			
<div style="float: left; width: 40%;"> © 2025 BY COMMONWEALTH ENGINEERS, INC. ALL RIGHTS RESERVED. REPRODUCTION BY ANY METHOD IN WHOLE OR PART WITHOUT PERMISSION IS PROHIBITED. </div> <div style="float: right; width: 60%; text-align: center;">  <p>Know what's below. 811 before you dig. 1-800-382-5544 <small>(IT'S THE LAW)</small></p> </div> <div style="clear: both;"></div>			
No.	Submit / Revision	By	Date
Designed By:	Drawn By:	Checked By:	
AL	SSE	RAL	
Issue Date:	Project No:	Scale:	
SUBMITTAL	W24156	AS SHOWN	
PLAN VIEW			
Drawing No:			
W2-01			
Sheet	10	OF	86

FOR CONTINUATION SEE DWG W2-01


- PROPOSED PLAN NOTES:
- 1 CONTRACTOR SHALL VERIFY THE EXISTING SERVICE LINE MATERIAL TO BE EITHER LEAD OR GALVANIZED PRIOR TO REPLACING THE SERVICE LINE. CONTRACTOR SHALL POTHOLE THE CITY-OWNED SIDE OF THE SERVICE LINE A MINIMUM OF 3 FT BACK FROM CURB STOP.
 - 2 NEW 1" WATER SERVICE AND CURB STOP OR METER PIT
 - 3 NEW 1-1/2" WATER SERVICE AND CURB STOP OR METER PIT
 - 4 CURB STOP AND/OR METER PIT IS SHOWN FOR REPLACEMENT AND COULD NOT BE LOCATED IN THE FIELD. CONTRACTOR SHALL LOCATE PRIOR TO REPLACEMENT.
 - 5 CONTRACTOR SHALL DISCONNECT EXISTING SERVICE LINE AT WATER MAIN AND ABANDON. EXISTING SERVICE LINE SHALL BE CUT AND CRIMPED. SERVICE LINE SHALL NOT BE REPLACED SINCE LOT IS EMPTY.




FOR CONTINUATION SEE DWG W3-04

PLAN VIEW

SCALE: 1"=20'-0"

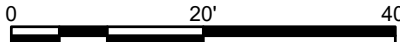

OFFICE LOCATIONS IN:
INDIANAPOLIS, IN (2)
EVANSVILLE, IN
FORT WAYNE, IN
CROWN POINT, IN
BOWLING GREEN, KY
SOUTH BEND, IN

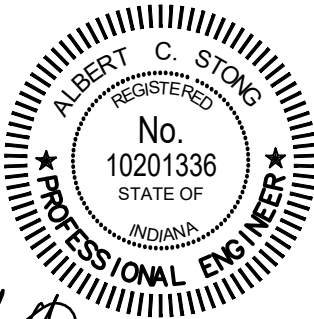

Signature: *Albert C. Stong* Date: 4/01/2025

CITY OF ROCHESTER
FULTON COUNTY, INDIANA
LEAD SERVICE LINE
REPLACEMENT PROJECT - DAC
AREA

© 2023 BY COMMONWEALTH ENGINEERS, INC. ALL RIGHTS RESERVED. REPRODUCTION BY ANY METHOD IN WHOLE OR IN PART WITHOUT PERMISSION IS PROHIBITED.



No.	Submittal / Revision	By	Date

Designed By: AL	Drawn By: SSE	Checked By: RAL
Issue Date: SUBMITTAL	Project No: W24156	Scale: AS SHOWN

PLAN VIEW

Drawing No:

W2-02

Sheet: 11 OF 86

CONTRACTOR SHALL VERIFY THE EXISTING SERVICE LINE MATERIAL TO BE EITHER LEAD OR GALVANIZED PRIOR TO REPLACING THE SERVICE LINE. CONTRACTOR SHALL POTHOLE THE CITY-OWNED SIDE OF THE SERVICE LINE A MINIMUM OF 3 FT BACK FROM CURB STOP.

NEW 1" WATER SERVICE AND CURB STOP OR METER PIT


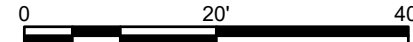
NEW 1-1/2" WATER SERVICE AND CURB STOP OR METER PIT

CURB STOP AND/OR METER PIT IS SHOWN FOR REPLACEMENT AND COULD NOT BE LOCATED IN THE FIELD. CONTRACTOR SHALL LOCATE PRIOR TO REPLACEMENT.

CONTRACTOR SHALL DISCONNECT EXISTING SERVICE LINE AT WATER MAIN AND ABANDON. EXISTING SERVICE LINE SHALL BE CUT AND CRIMPED. SERVICE LINE SHALL NOT BE REPLACED SINCE LOT IS EMPTY.



SCALE: 1"=20'-0"



Signature _____ 4/01/2014

Date _____

**CITY OF ROCHESTER
FULTON COUNTY, INDIANA
LEAD SERVICE LINE
REPLACEMENT PROJECT - DAC
AREA**

© 2023 BY COMMONWEALTH
ENGINEERS, INC. ALL RIGHTS
RESERVED. REPRODUCTION
BY ANY METHOD IN WHOLE
OR IN PART WITHOUT
PERMISSION IS PROHIBITED

Indiana811

Know what's below. 811 before you dig.

1-800-382-5544
(IT'S THE LAW)

[illegible]

Designed By: AL	Drawn By: SSE	Checked By: RAL
Issue Date: SUBMITTAL	Project No: W24156	Scale: AS SHOWN

PLAN VIEW

Drawing No:

W2-03

Sheet: 12 OF 86

FOR CONTINUATION SEE DWG W2-04

FOR CONTINUATION SEE DWG W1-01



FOR CONTINUATION SEE DWG W2-06

**CITY OF ROCHESTER
FULTON COUNTY, INDIANA
LEAD SERVICE LINE
REPLACEMENT PROJECT - DAC
AREA**

© 2023 BY COMMONWEALTH ENGINEERS, INC. ALL RIGHTS RESERVED. REPRODUCTION BY ANY METHOD IN WHOLE OR IN PART WITHOUT PERMISSION IS PROHIBITED

Know what's below. 811 before you dig.
1-800-382-5544
(ITS THE LAW)

[illegible]

Designed By: AL	Drawn By: SSE	Checked By: RAL
Issue Date: SUBMITTAL	Project No: W24156	Scale: AS SHOWN

PLAN VIEW

Drawing No:


W2-05

Sheet: 14 OF 86



COMMONWEALTHTM
ENGINEERS, INC.
A wealth of resources to master a common goal

<https://commonwealthengineers.com/>

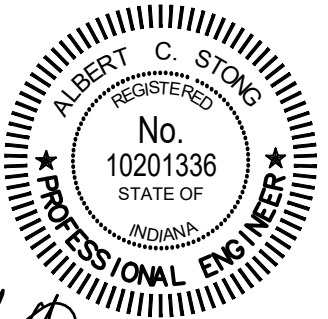

Signature _____

4/01/2025
Date




FOR CONTINUATION SEE DWG W3-08

PLAN VIEW

SCALE: 1"=20'-0"

FOR CONTINUATION SEE DWG W2-07




**COMMONWEALTH
ENGINEERS, INC.**

A wealth of resources to make a common goal.

<https://commonwealthengineers.com/>

OFFICE LOCATIONS IN:

- INDIANAPOLIS, IN. (2)
- EVANSVILLE, IN.
- FORT WAYNE, IN.
- CROWN POINT, IN.
- BOWLING GREEN, KY.
- SOUTH BEND, IN.

Signature  _____

4/01/2025
Date

**CITY OF ROCHESTER
FULTON COUNTY, INDIANA
LEAD SERVICE LINE
REPLACEMENT PROJECT - DAC
AREA**

© 2023 BY COMMONWEALTH ENGINEERS, INC. ALL RIGHTS RESERVED. REPRODUCTION BY ANY METHOD IN WHOLE OR IN PART WITHOUT PERMISSION IS PROHIBITED

Indiana 811

Know what's below. 811 before you dig.

1-800-382-5544
(IT'S THE LAW)

[illegible]

Designed By: AL	Drawn By: SSE	Checked By: RAL
Issue Date: SUBMITTAL	Project No: W24156	Scale: AS SHOWN

PLAN VIEW

Drawing No:

W2-06

Sheet: 15 OF 86

FOR CONTINUATION SEE DWG W2-06



FOR CONTINUATION SEE DWG W2-08



PROPOSED PLAN NOTES:

- 1 CONTRACTOR SHALL VERIFY THE EXISTING SERVICE LINE MATERIAL TO BE EITHER LEAD OR GALVANIZED PRIOR TO REPLACING THE SERVICE LINE. CONTRACTOR SHALL POTHOLE THE CITY-OWNED SIDE OF THE SERVICE LINE A MINIMUM OF 3 FT BACK FROM CURB STOP.
- 2 NEW 1" WATER SERVICE AND CURB STOP OR METER PIT
- 3 NEW 1-1/2" WATER SERVICE AND CURB STOP OR METER PIT
- 4 CURB STOP AND/OR METER PIT IS SHOWN FOR REPLACEMENT AND COULD NOT BE LOCATED IN THE FIELD. CONTRACTOR SHALL LOCATE PRIOR TO REPLACEMENT.
- 5 CONTRACTOR SHALL DISCONNECT EXISTING SERVICE LINE AT WATER MAIN AND ABANDON. EXISTING SERVICE LINE SHALL BE CUT AND CRIMPED. SERVICE LINE SHALL NOT BE REPLACED SINCE LOT IS EMPTY.

FOR CONTINUATION SEE DWG W3-09

PLAN VIEW

SCALE: 1"=20'-0"

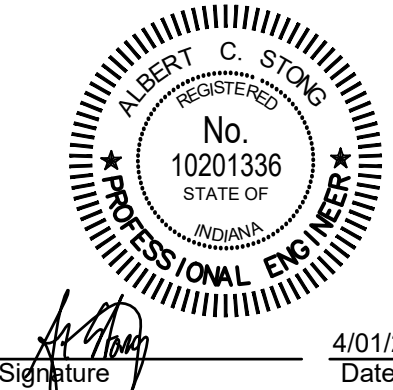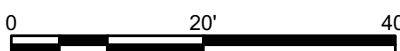

CITY OF ROCHESTER
FULTON COUNTY, INDIANA
LEAD SERVICE LINE
REPLACEMENT PROJECT - DAC
AREA

© 2023 BY COMMONWEALTH ENGINEERS, INC. ALL RIGHTS RESERVED. REPRODUCTION BY ANY METHOD IN WHOLE OR IN PART WITHOUT PERMISSION IS PROHIBITED.
Indiana 811
Know what's below. 811 before you dig.
1-800-382-5544
(IT'S THE LAW)

No.	Submittal / Revision	By	Date

Designed By: AL	Drawn By: SSE	Checked By: RAL
Issue Date: SUBMITTAL	Project No: W24156	Scale: AS SHOWN

PLAN VIEW

Drawing No:
W2-07
Sheet: 16 OF 86



FOR CONTINUATION SEE DWG W3-10

PLAN VIEW

SCALE: 1"=20'-0"


PROPOSED PLAN NOTES:

- 1 CONTRACTOR SHALL VERIFY THE EXISTING SERVICE LINE MATERIAL TO BE EITHER LEAD OR GALVANIZED PRIOR TO REPLACING THE SERVICE LINE. CONTRACTOR SHALL POTHOLE THE CITY-OWNED SIDE OF THE SERVICE LINE A MINIMUM OF 3 FT BACK FROM CURB STOP.
- 2 NEW 1" WATER SERVICE AND CURB STOP OR METER PIT
- 3 NEW 1-1/2" WATER SERVICE AND CURB STOP OR METER PIT
- 4 CURB STOP AND/OR METER PIT IS SHOWN FOR REPLACEMENT AND COULD NOT BE LOCATED IN THE FIELD. CONTRACTOR SHALL LOCATE PRIOR TO REPLACEMENT.
- 5 CONTRACTOR SHALL DISCONNECT EXISTING SERVICE LINE AT WATER MAIN AND ABANDON. EXISTING SERVICE LINE SHALL BE CUT AND CRIMPED. SERVICE LINE SHALL NOT BE REPLACED SINCE LOT IS EMPTY.



FOR CONTINUATION SEE DWG W3-11


SCALE: 1"=20'-0"

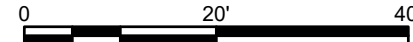

- ① CONTRACTOR SHALL VERIFY THE EXISTING SERVICE LINE MATERIAL TO BE EITHER LEAD OR GALVANIZED PRIOR TO REPLACING THE SERVICE LINE. CONTRACTOR SHALL POTHOLE THE CITY-OWNED SIDE OF THE SERVICE LINE A MINIMUM OF 3 FT BACK FROM CURB STOP.
- ② NEW 1" WATER SERVICE AND CURB STOP OR METER PIT
- ③ NEW 1-1/2" WATER SERVICE AND CURB STOP OR METER PIT
- ④ CURB STOP AND/OR METER PIT IS SHOWN FOR REPLACEMENT AND COULD NOT BE LOCATED IN THE FIELD. CONTRACTOR SHALL LOCATE PRIOR TO REPLACEMENT.
- ⑤ CONTRACTOR SHALL DISCONNECT EXISTING SERVICE LINE AT WATER MAIN AND ABANDON. EXISTING SERVICE LINE SHALL BE CUT AND CRIMPED. SERVICE LINE SHALL NOT BE REPLACED SINCE LOT IS EMPTY.



<https://commonwealthengineers.com/>

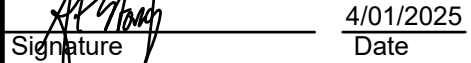

**CITY OF ROCHESTER
FULTON COUNTY, INDIANA**

[illegible]

Know what's below. 811 before you dig.
1-800-382-5544
(ITS THE LAW)

PLAN VIEW

W2-09


Sheet: 18 OF 86



FOR CONTINUATION SEE DWG W4-01

PLAN VIEW

SCALE: 1"=20'-0"

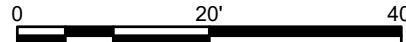


PROPOSED PLAN NOTES:

- CONTRACTOR SHALL VERIFY THE EXISTING SERVICE LINE MATERIAL TO BE EITHER LEAD OR GALVANIZED PRIOR TO REPLACING THE SERVICE LINE. CONTRACTOR SHALL POTHOLE THE CITY-OWNED SIDE OF THE SERVICE LINE A MINIMUM OF 3 FT BACK FROM CURB STOP.
- NEW 1" WATER SERVICE AND CURB STOP OR METER PIT
- NEW 1-1/2" WATER SERVICE AND CURB STOP OR METER PIT
- CURB STOP AND/OR METER PIT IS SHOWN FOR REPLACEMENT AND COULD NOT BE LOCATED IN THE FIELD. CONTRACTOR SHALL LOCATE PRIOR TO REPLACEMENT.
- CONTRACTOR SHALL DISCONNECT EXISTING SERVICE LINE AT WATER MAIN AND ABANDON. EXISTING SERVICE LINE SHALL BE CUT AND CRIMPED. SERVICE LINE SHALL NOT BE REPLACED SINCE LOT IS EMPTY.

FOR CONTINUATION SEE DWG W3-02



COMMONWEALTH ENGINEERS, INC.
A member of the Commonwealth Engineering Group

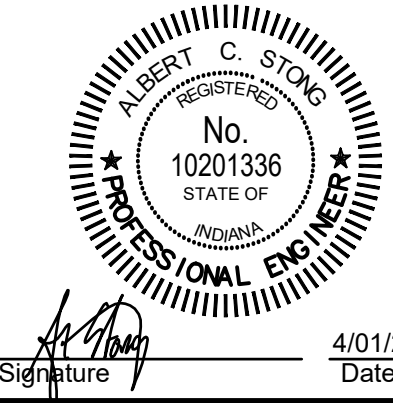

Signature: *Albert C. Stong* Date: 4/01/2025

**CITY OF ROCHESTER
FULTON COUNTY, INDIANA
LEAD SERVICE LINE
REPLACEMENT PROJECT - DAC
AREA**

© 2023 BY COMMONWEALTH ENGINEERS, INC. ALL RIGHTS RESERVED. REPRODUCTION BY ANY METHOD IN WHOLE OR IN PART WITHOUT PERMISSION IS PROHIBITED



Know what's below. 811 before you dig.
1-800-382-5544
(IT'S THE LAW)

No.	Submittal / Revision	By	Date

Designed By: AL	Drawn By: SSE	Checked By: RAL
Issue Date: SUBMITTAL	Project No: W24156	Scale: AS SHOWN

PLAN VIEW

Drawing No:

W3-01

Sheet: 19 OF 86

CONTRACTOR SHALL VERIFY THE EXISTING SERVICE LINE MATERIAL TO BE EITHER LEAD OR GALVANIZED PRIOR TO REPLACING THE SERVICE LINE. CONTRACTOR SHALL POTHOLE THE CITY-OWNED SIDE OF THE SERVICE LINE A MINIMUM OF 3 FT BACK FROM CURB STOP.

NEW 1" WATER SERVICE AND CURB STOP OR METER PIT


NEW 1-1/2" WATER SERVICE AND CURB STOP OR METER PIT

CURB STOP AND/OR METER PIT IS SHOWN FOR REPLACEMENT AND COULD NOT BE LOCATED IN THE FIELD. CONTRACTOR SHALL LOCATE PRIOR TO REPLACEMENT.

CONTRACTOR SHALL DISCONNECT EXISTING SERVICE LINE AT WATER MAIN AND ABANDON. EXISTING SERVICE LINE SHALL BE CUT AND CRIMPED. SERVICE LINE SHALL NOT BE REPLACED SINCE LOT IS EMPTY.



PLAN VIEW



Signature: *Albert C. Stong*

4/01/2014

Date: _____

**CITY OF ROCHESTER
FULTON COUNTY, INDIANA
LEAD SERVICE LINE
REPLACEMENT PROJECT - DAC
AREA**

Indiana 811

Know what's below. 811 before you dig.

1-800-382-5544
(IT'S THE LAW)

[illegible]

Designed By: AL	Drawn By: SSE	Checked By: RAL
Issue Date: SUBMITTAL	Project No: W24156	Scale: AS SHOWN

PLAN VIEW

Drawing No:


V3-02

Sheet: 20 OF 86


FOR CONTINUATION SEE DWG W4-03



SCALE: 1"=20'-0"

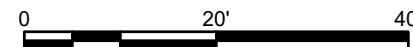

- PROPOSED PLAN NOTES:**
- 1 CONTRACTOR SHALL VERIFY THE EXISTING SERVICE LINE MATERIAL TO BE EITHER LEAD OR GALVANIZED PRIOR TO REPLACING THE SERVICE LINE. CONTRACTOR SHALL POTHOLE THE CITY-OWNED SIDE OF THE SERVICE LINE A MINIMUM OF 3 FT BACK FROM CURB STOP.
 - 2 NEW 1" WATER SERVICE AND CURB STOP OR METER PIT
 - 3 NEW 1-1/2" WATER SERVICE AND CURB STOP OR METER PIT
 - 4 CURB STOP AND/OR METER PIT IS SHOWN FOR REPLACEMENT AND COULD NOT BE LOCATED IN THE FIELD. CONTRACTOR SHALL LOCATE PRIOR TO REPLACEMENT.
 - 5 CONTRACTOR SHALL DISCONNECT EXISTING SERVICE LINE AT WATER MAIN AND ABANDON. EXISTING SERVICE LINE SHALL BE CUT AND CRIMPED. SERVICE LINE SHALL NOT BE REPLACED SINCE LOT IS EMPTY.

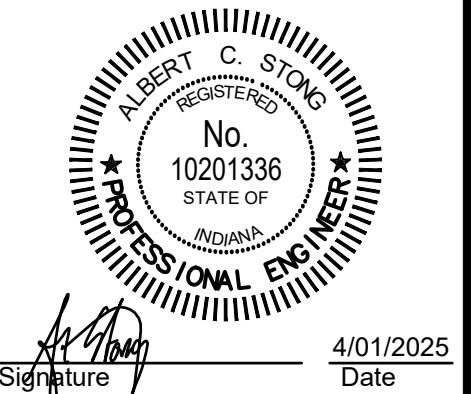

**CITY OF ROCHESTER
FULTON COUNTY, INDIANA
LEAD SERVICE LINE
REPLACEMENT PROJECT - DAC
AREA**

© 2023 BY COMMONWEALTH ENGINEERS, INC. ALL RIGHTS RESERVED. REPRODUCTION BY ANY METHOD IN WHOLE OR IN PART WITHOUT PERMISSION IS PROHIBITED

[illegible]

Designed By: AL	Drawn By: SSE	Checked By: RAL
Issue Date: SUBMITTAL	Project No: W24156	Scale: AS SHOWN

PLAN VIEW

Drawing No:
W3-03
Sheet: 21 OF 86

FOR CONTINUATION SEE DWG W3-03

FOR CONTINUATION SEE DWG W1-05

FOR CONTINUATION SEE DWG W3-05



PROPOSED PLAN NOTES:

- 1 CONTRACTOR SHALL VERIFY THE EXISTING SERVICE LINE MATERIAL TO BE EITHER LEAD OR GALVANIZED PRIOR TO REPLACING THE SERVICE LINE. CONTRACTOR SHALL POTHOLE THE CITY-OWNED SIDE OF THE SERVICE LINE A MINIMUM OF 3 FT BACK FROM CURB STOP.
- 2 NEW 1" WATER SERVICE AND CURB STOP OR METER PIT
- 3 NEW 1-1/2" WATER SERVICE AND CURB STOP OR METER PIT
- 4 CURB STOP AND/OR METER PIT IS SHOWN FOR REPLACEMENT AND COULD NOT BE LOCATED IN THE FIELD. CONTRACTOR SHALL LOCATE PRIOR TO REPLACEMENT.
- 5 CONTRACTOR SHALL DISCONNECT EXISTING SERVICE LINE AT WATER MAIN AND ABANDON. EXISTING SERVICE LINE SHALL BE CUT AND CRIMPED. SERVICE LINE SHALL NOT BE REPLACED SINCE LOT IS EMPTY.

FOR CONTINUATION SEE DWG W4-04

PLAN VIEW

SCALE: 1"=20'-0"

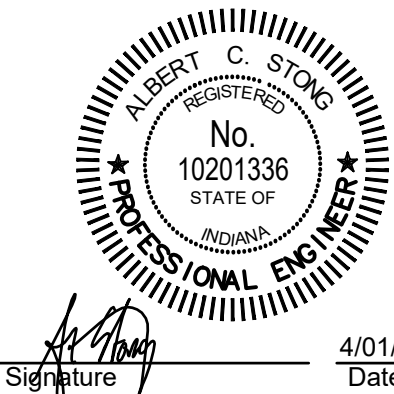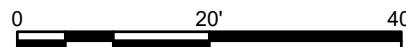

Signature: [Signature] Date: 4/01/2025

CITY OF ROCHESTER
FULTON COUNTY, INDIANA
LEAD SERVICE LINE
REPLACEMENT PROJECT - DAC
AREA

© 2023 BY COMMONWEALTH ENGINEERS, INC. ALL RIGHTS RESERVED. REPRODUCTION BY ANY METHOD IN WHOLE OR IN PART WITHOUT PERMISSION IS PROHIBITED.
Indiana 811
Know what's below. 811 before you dig.
1-800-382-5544
(IT'S THE LAW)

No.	Submittal / Revision	By	Date

Designed By: AL	Drawn By: SSE	Checked By: RAL
Issue Date: SUBMITTAL	Project No: W24156	Scale: AS SHOWN

PLAN VIEW

Drawing No:
W3-04
Sheet: 22 OF 86


FOR CONTINUATION SEE DWG W4-05



PLAN VIEW

SCALE: 1"=20'-0"

- ① CONTRACTOR SHALL VERIFY THE EXISTING SERVICE LINE MATERIAL TO BE EITHER LEAD OR GALVANIZED PRIOR TO REPLACING THE SERVICE LINE. CONTRACTOR SHALL POTHOLE THE CITY-OWNED SIDE OF THE SERVICE LINE A MINIMUM OF 3 FT BACK FROM CURB STOP.
- ② NEW 1" WATER SERVICE AND CURB STOP OR METER PIT
- ③ NEW 1-1/2" WATER SERVICE AND CURB STOP OR METER PIT
- ④ CURB STOP AND/OR METER PIT IS SHOWN FOR REPLACEMENT AND COULD NOT BE LOCATED IN THE FIELD. CONTRACTOR SHALL LOCATE PRIOR TO REPLACEMENT.
- ⑤ CONTRACTOR SHALL DISCONNECT EXISTING SERVICE LINE AT WATER MAIN AND ABANDON. EXISTING SERVICE LINE SHALL BE CUT AND CRIMPED. SERVICE LINE SHALL NOT BE REPLACED SINCE LOT IS EMPTY.

Signature  4/01/2025
Date

© 2023 BY COMMONWEALTH ENGINEERS, INC. ALL RIGHTS RESERVED. REPRODUCTION BY ANY METHOD IN WHOLE OR IN PART WITHOUT PERMISSION IS PROHIBITED

Indiana 811

Know what's below. 811 before you dig.

1-800-382-5544
(IT'S THE LAW)

Designed By: AL	Drawn By: SSE	Checked By: RAL
Issue Date: SUBMITTAL	Project No: W24156	Scale: AS SHOWN

Drawing No:

et: 23 OF

FOR CONTINUATION SEE DWG W3-05


FOR CONTINUATION SEE DWG W2-04



FOR CONTINUATION SEE DWG W4-06

PLAN VIEW

SCALE: 1"=20'-0"

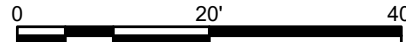

PROPOSED PLAN NOTES:

- ① CONTRACTOR SHALL VERIFY THE EXISTING SERVICE LINE MATERIAL TO BE EITHER LEAD OR GALVANIZED PRIOR TO REPLACING THE SERVICE LINE. CONTRACTOR SHALL POTHOLE THE CITY-OWNED SIDE OF THE SERVICE LINE A MINIMUM OF 3 FT BACK FROM CURB STOP.
- ② NEW 1" WATER SERVICE AND CURB STOP OR METER PIT
- ③ NEW 1-1/2" WATER SERVICE AND CURB STOP OR METER PIT
- ④ CURB STOP AND/OR METER PIT IS SHOWN FOR REPLACEMENT AND COULD NOT BE LOCATED IN THE FIELD. CONTRACTOR SHALL LOCATE PRIOR TO REPLACEMENT.
- ⑤ CONTRACTOR SHALL DISCONNECT EXISTING SERVICE LINE AT WATER MAIN AND ABANDON. EXISTING SERVICE LINE SHALL BE CUT AND CRIMPED. SERVICE LINE SHALL NOT BE REPLACED SINCE LOT IS EMPTY.

FOR CONTINUATION SEE DWG W3-07

[illegible]


FOR CONTINUATION SEE DWG W4-07



PROPOSED PLAN NOTES:

- ① CONTRACTOR SHALL VERIFY THE EXISTING SERVICE LINE MATERIAL TO BE EITHER LEAD OR GALVANIZED PRIOR TO REPLACING THE SERVICE LINE. CONTRACTOR SHALL POTHOLE THE CITY-OWNED SIDE OF THE SERVICE LINE A MINIMUM OF 3 FT BACK FROM CURB STOP.
- ② NEW 1" WATER SERVICE AND CURB STOP OR METER PIT
- ③ NEW 1-1/2" WATER SERVICE AND CURB STOP OR METER PIT
- ④ CURB STOP AND/OR METER PIT IS SHOWN FOR REPLACEMENT AND COULD NOT BE LOCATED IN THE FIELD. CONTRACTOR SHALL LOCATE PRIOR TO REPLACEMENT.
- ⑤ CONTRACTOR SHALL DISCONNECT EXISTING SERVICE LINE AT WATER MAIN AND ABANDON. EXISTING SERVICE LINE SHALL BE CUT AND CRIMPED. SERVICE LINE SHALL NOT BE REPLACED SINCE LOT IS EMPTY.


SCALE: 1"=20'-0"

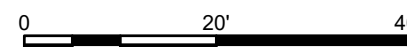

FOR CONTINUATION SEE DWG W3-08



<https://commonwealthengineers.com/>

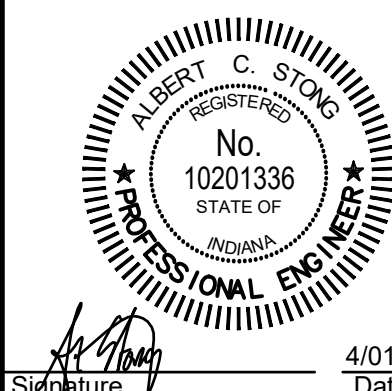

Signature 4/01/2025
Date

**CITY OF ROCHESTER
FULTON COUNTY, INDIANA
LEAD SERVICE LINE
REPLACEMENT PROJECT - DAC
AREA**

© 2023 BY COMMONWEALTH ENGINEERS, INC. ALL RIGHTS RESERVED. REPRODUCTION BY ANY METHOD IN WHOLE OR IN PART WITHOUT PERMISSION IS PROHIBITED



Know what's below. 811 before you dig.
1-800-382-5544
(ITS THE LAW)

[illegible]

Designed By:	Drawn By:	Checked By:
--------------	-----------	-------------

Issue Date: SUBMITTAL	Project No: W24156	Scale: AS SHOWN
--------------------------	-----------------------	--------------------

PLAN VIEW

Drawing No:

W3-07


Sheet: 25 OF 86

FOR CONTINUATION SEE DWG W4-08



- ① CONTRACTOR SHALL VERIFY THE EXISTING SERVICE LINE MATERIAL TO BE EITHER LEAD OR GALVANIZED PRIOR TO REPLACING THE SERVICE LINE. CONTRACTOR SHALL POTHOLE THE CITY-OWNED SIDE OF THE SERVICE LINE A MINIMUM OF 3 FT BACK FROM CURB STOP.
- ② NEW 1" WATER SERVICE AND CURB STOP OR METER PIT
- ③ NEW 1-1/2" WATER SERVICE AND CURB STOP OR METER PIT
- ④ CURB STOP AND/OR METER PIT IS SHOWN FOR REPLACEMENT AND COULD NOT BE LOCATED IN THE FIELD. CONTRACTOR SHALL LOCATE PRIOR TO REPLACEMENT.
- ⑤ CONTRACTOR SHALL DISCONNECT EXISTING SERVICE LINE AT WATER MAIN AND ABANDON. EXISTING SERVICE LINE SHALL BE CUT AND CRIMPED. SERVICE LINE SHALL NOT BE REPLACED SINCE LOT IS EMPTY.

FOR CONTINUATION SEE DWG W3-09

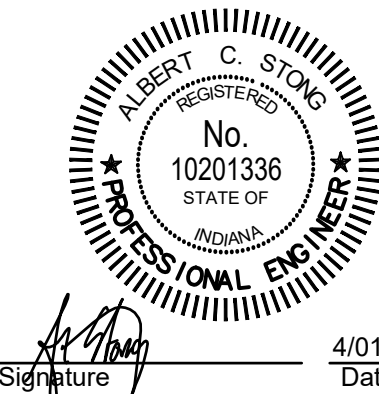

© 2023 BY COMMONWEALTH ENGINEERS, INC. ALL RIGHTS RESERVED. REPRODUCTION BY ANY METHOD IN WHOLE OR IN PART WITHOUT PERMISSION IS PROHIBITED

Know what's below. 811 before you dig.

s below. 811 before

s below. 811 before

Designed By: AL	Drawn By: SSE	Checked By: RAL
Issue Date: SUBMITTAL	Project No: W24156	Scale: AS SHOWN

Drawing No:

W3-08

Sheet: 26 OF 86

FOR CONTINUATION SEE DWG W3-08


FOR CONTINUATION SEE DWG W2-07

FOR CONTINUATION SEE DWG W3-10

FOR CONTINUATION SEE DWG W4-09

PLAN VIEW

SCALE: 1"=20'-0"

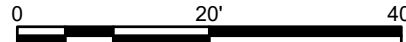

PROPOSED PLAN NOTES:

- CONTRACTOR SHALL VERIFY THE EXISTING SERVICE LINE MATERIAL TO BE EITHER LEAD OR GALVANIZED PRIOR TO REPLACING THE SERVICE LINE. CONTRACTOR SHALL POTHOLE THE CITY-OWNED SIDE OF THE SERVICE LINE A MINIMUM OF 3 FT BACK FROM CURB STOP.
- NEW 1" WATER SERVICE AND CURB STOP OR METER PIT
- NEW 1-1/2" WATER SERVICE AND CURB STOP OR METER PIT
- CURB STOP AND/OR METER PIT IS SHOWN FOR REPLACEMENT AND COULD NOT BE LOCATED IN THE FIELD. CONTRACTOR SHALL LOCATE PRIOR TO REPLACEMENT.
- CONTRACTOR SHALL DISCONNECT EXISTING SERVICE LINE AT WATER MAIN AND ABANDON. EXISTING SERVICE LINE SHALL BE CUT AND CRIMPED. SERVICE LINE SHALL NOT BE REPLACED SINCE LOT IS EMPTY.

CITY OF ROCHESTER
FULTON COUNTY, INDIANA
LEAD SERVICE LINE
REPLACEMENT PROJECT - DAC
AREA

© 2023 BY COMMONWEALTH
ENGINEERS, INC. ALL RIGHTS
RESERVED. REPRODUCTION
BY ANY METHOD IN WHOLE
OR IN PART WITHOUT THE
PERMISSION IS PROHIBITED

Indiana 811
Know what's below. 811 before you dig.
1-800-382-5544
(IT'S THE LAW)

No.	Submittal / Revision	By	Date


Designed By: AL	Drawn By: SSE	Checked By: RAL
Issue Date: SUBMITTAL	Project No: W24156	Scale: AS SHOWN

PLAN VIEW

Drawing No:

W3-09

Sheet: 27 OF 86

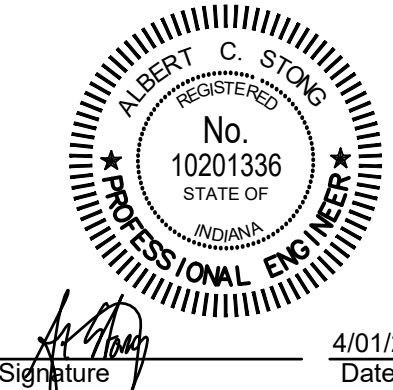

Signature: *Albert C. Stong* Date: 4/01/2025


COMMONWEALTH ENGINEERS, INC.
A member of the Commonwealth Engineers Group
<https://commonwealthengineers.com/>
OFFICE LOCATIONS IN:
INDIANAPOLIS, IN (2)
EVANSVILLE, IN
FORT WAYNE, IN
CROWN POINT, IN
BOWLING GREEN, KY
SOUTH BEND, IN



FOR CONTINUATION SEE DWG W4-10

SCALE: 1"=20'-0"

SCALE: 1"=20'-0"

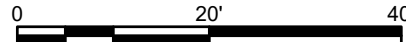


- ①

FOR CONTINUATION SEE DWG W3-11

© 2023 BY COMMONWEALTH ENGINEERS, INC. ALL RIGHTS RESERVED.

CITY OF ROCHESTER
FULTON COUNTY, INDIANA
LEAD SERVICE LINE
REPLACEMENT PROJECT - DAC
AREA




**COMMONWEALTH
ENGINEERS, INC.**


A wealth of resources to build a common goal.

<http://commonwealthengineers.com/>

OFFICE LOCATIONS IN:

- INDIANAPOLIS, IN. (2)
- EVANSVILLE, IN.
- FORT WAYNE, IN.
- CROWN POINT, IN.
- BOWLING GREEN, KY.
- SOUTH BEND, IN.

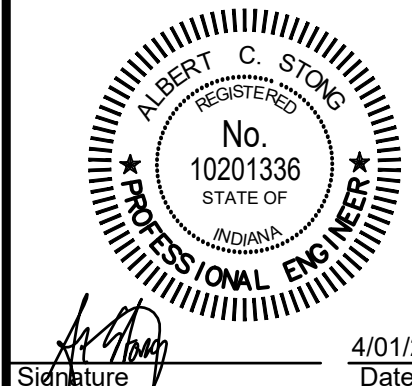

	4/01/2025
Signature	Date

© 2023 BY COMMONWEALTH ENGINEERS, INC. ALL RIGHTS RESERVED. REPRODUCTION BY ANY METHOD IN WHOLE OR IN PART WITHOUT PERMISSION IS PROHIBITED

Indiana 811

Know what's below. 811 before you dig.
1-800-382-5544
(IT'S THE LAW)

[illegible]

Designed By: AL	Drawn By: SSE	Checked By: RAL
Issue Date: SUBMITTAL	Project No: W24156	Scale: AS SHOWN

PLAN VIEW

Drawing No:
W3-10
Sheet: 28 OF 86

PROPOSED PLAN NOTES:

- 1 CONTRACTOR SHALL VERIFY THE EXISTING SERVICE LINE MATERIAL TO BE EITHER LEAD OR GALVANIZED PRIOR TO REPLACING THE SERVICE LINE. CONTRACTOR SHALL POTHOLE THE CITY-OWNED SIDE OF THE SERVICE LINE A MINIMUM OF 3 FT BACK FROM CURB STOP.
- 2 NEW 1" WATER SERVICE AND CURB STOP OR METER PIT
- 3 NEW 1-1/2" WATER SERVICE AND CURB STOP OR METER PIT
- 4 CURB STOP AND/OR METER PIT IS SHOWN FOR REPLACEMENT AND COULD NOT BE LOCATED IN THE FIELD. CONTRACTOR SHALL LOCATE PRIOR TO REPLACEMENT.
- 5 CONTRACTOR SHALL DISCONNECT EXISTING SERVICE LINE AT WATER MAIN AND ABANDON. EXISTING SERVICE LINE SHALL BE CUT AND CRIMPED. SERVICE LINE SHALL NOT BE REPLACED SINCE LOT IS EMPTY.


FOR CONTINUATION SEE DWG W3-10



FOR CONTINUATION SEE DWG W4-11

PLAN VIEW

SCALE: 1"=20'-0"

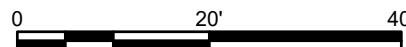

FOR CONTINUATION SEE DWG W3-12

CITY OF ROCHESTER
FULTON COUNTY, INDIANA
LEAD SERVICE LINE
REPLACEMENT PROJECT - DAC
AREA

© 2023 BY COMMONWEALTH ENGINEERS, INC. ALL RIGHTS RESERVED. REPRODUCTION BY ANY METHOD IN WHOLE OR IN PART WITHOUT PERMISSION IS PROHIBITED.
Indiana 811
Know what's below. 811 before you dig.
1-800-382-5544
(IT'S THE LAW)

No.	Submittal / Revision	By	Date


Designed By: AL	Drawn By: SSE	Checked By: RAL
Issue Date: SUBMITTAL	Project No: W24156	Scale: AS SHOWN

PLAN VIEW

Drawing No:

W3-11


Sheet: 29 OF 86

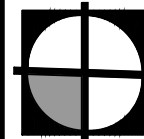

COMMONWEALTH ENGINEERS, INC.
A member of the Commonwealth Engineers Group

<https://commonwealthengineers.com/>

OFFICE LOCATIONS IN:
INDIANAPOLIS, IN (2)
EVANSVILLE, IN
FORT WAYNE, IN
CROWN POINT, IN
BOWLING GREEN, KY
SOUTH BEND, IN

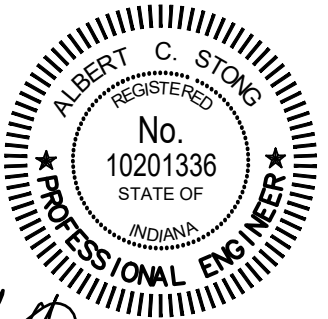

Signature: *Albert C. Stong* Date: 4/01/2025




FOR CONTINUATION SEE DWG W3-11

FOR CONTINUATION SEE DWG W4-12

PLAN VIEW

SCALE: 1"=20'-0"

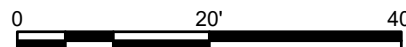


PROPOSED PLAN NOTES:

- ① CONTRACTOR SHALL VERIFY THE EXISTING SERVICE LINE MATERIAL TO BE EITHER LEAD OR GALVANIZED PRIOR TO REPLACING THE SERVICE LINE. CONTRACTOR SHALL POTHOLE THE CITY-OWNED SIDE OF THE SERVICE LINE A MINIMUM OF 3 FT BACK FROM CURB STOP.
- ② NEW 1" WATER SERVICE AND CURB STOP OR METER PIT
- ③ NEW 1-1/2" WATER SERVICE AND CURB STOP OR METER PIT
- ④ CURB STOP AND/OR METER PIT IS SHOWN FOR REPLACEMENT AND COULD NOT BE LOCATED IN THE FIELD. CONTRACTOR SHALL LOCATE PRIOR TO REPLACEMENT.
- ⑤ CONTRACTOR SHALL DISCONNECT EXISTING SERVICE LINE AT WATER MAIN AND ABANDON. EXISTING SERVICE LINE SHALL BE CUT AND CRIMPED. SERVICE LINE SHALL NOT BE REPLACED SINCE LOT IS EMPTY.



COMMONWEALTHTM
ENGINEERS, INC.
 A wealth of resources to master a common goal.



Signature _____ 4/01/2014
Date _____

**COMMONWEALTH
ENGINEERS, INC.**
A wealth of resources to make a common goal.

commonwealthengineers.com/

OFFICE LOCATIONS IN:

INDIANAPOLIS, IN. (2)
EVANSVILLE, IN.
FORT WAYNE, IN.
CROWN POINT, IN.
BOWLING GREEN, KY.
SOUTH BEND, IN.

**CITY OF ROCHESTER
FULTON COUNTY, INDIANA
LEAD SERVICE LINE
REPLACEMENT PROJECT - DAC
AREA**

© 2023 BY COMMONWEALTH ENGINEERS, INC. ALL RIGHTS RESERVED. REPRODUCTION BY ANY METHOD IN WHOLE OR IN PART WITHOUT PERMISSION IS PROHIBITED

Indiana811

[illegible]

Designed By: AL	Drawn By: SSE	Checked By: RAL
Issue Date: SUBMITTAL	Project No: W24156	Scale: AS SHOWN

PLAN VIEW

Drawing No:

W3-12

Sheet: 30 OF 86

FOR CONTINUATION SEE DWG W5-02



PLAN VIEW

SCALE: 1"=20'-0"

5 CONTRACTOR SHALL DISCONNECT EXISTING SERVICE LINE AT WATER MAIN AND ABANDON. EXISTING SERVICE LINE SHALL BE CUT AND CRIMPED. SERVICE LINE SHALL NOT BE REPLACED SINCE LOT IS EMPTY.

Signature 4/01/2025
Date

© 2023 BY COMMONWEALTH ENGINEERS, INC. ALL RIGHTS RESERVED. REPRODUCTION BY ANY METHOD IN WHOLE OR IN PART WITHOUT PERMISSION IS PROHIBITED

Indiana 811

Know what's below. 811 before you dig

1-800-382-5544
(IT'S THE LAW)

Designed By: AL	Drawn By: SSE	Checked By: RAL
Issue Date: SUBMITTAL	Project No: W24156	Scale: AS SHOWN

Drawing No:

31 OF 86



- 1 CONTRACTOR SHALL VERIFY THE EXISTING SERVICE LINE MATERIAL TO BE EITHER LEAD OR GALVANIZED PRIOR TO REPLACING THE SERVICE LINE. CONTRACTOR SHALL POTHOLE THE CITY-OWNED SIDE OF THE SERVICE LINE A MINIMUM OF 3 FT BACK FROM CURB STOP.
- 2 NEW 1" WATER SERVICE AND CURB STOP OR METER PIT
- 3 NEW 1-1/2" WATER SERVICE AND CURB STOP OR METER PIT
- 4 CURB STOP AND/OR METER PIT IS SHOWN FOR REPLACEMENT AND COULD NOT BE LOCATED IN THE FIELD. CONTRACTOR SHALL LOCATE PRIOR TO REPLACEMENT.
- 5 CONTRACTOR SHALL DISCONNECT EXISTING SERVICE LINE AT WATER MAIN AND ABANDON. EXISTING SERVICE LINE SHALL BE CUT AND CRIMPED. SERVICE LINE SHALL NOT BE REPLACED SINCE LOT IS EMPTY.

**CITY OF ROCHESTER
FULTON COUNTY, INDIANA
LEAD SERVICE LINE
REPLACEMENT PROJECT - DAC
AREA**

© 2023 BY COMMONWEALTH ENGINEERS, INC. ALL RIGHTS RESERVED. REPRODUCTION BY ANY MEANS OR IN ANY MANNER WITHOUT PERMISSION IS PROHIBITED

Indiana 811

Know what's below. 811 before you dig.
1-800-382-5544
(IT'S THE LAW)


[illegible]

Designed By: AL	Drawn By: SSE	Checked By: RAL
Issue Date: SUBMITTAL	Project No: W24156	Scale: AS SHOWN


PLAN VIEW

Drawing No:

W4-02

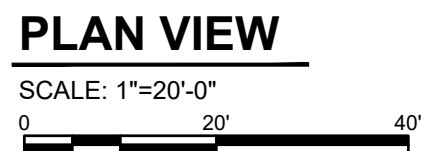

- ① CONTRACTOR SHALL VERIFY THE EXISTING SERVICE LINE MATERIAL TO BE EITHER LEAD OR GALVANIZED PRIOR TO REPLACING THE SERVICE LINE. CONTRACTOR SHALL POTHOLE THE CITY-OWNED SIDE OF THE SERVICE LINE A MINIMUM OF 3 FT BACK FROM CURB STOP.
- ② NEW 1" WATER SERVICE AND CURB STOP OR METER PIT
- ③ NEW 1-1/2" WATER SERVICE AND CURB STOP OR METER PIT
- ④ CURB STOP AND/OR METER PIT IS SHOWN FOR REPLACEMENT AND COULD NOT BE LOCATED IN THE FIELD. CONTRACTOR SHALL LOCATE PRIOR TO REPLACEMENT.
- ⑤ CONTRACTOR SHALL DISCONNECT EXISTING SERVICE LINE AT WATER MAIN AND ABANDON. EXISTING SERVICE LINE SHALL BE CUT AND CRIMPED. SERVICE LINE SHALL NOT BE REPLACED SINCE LOT IS EMPTY.

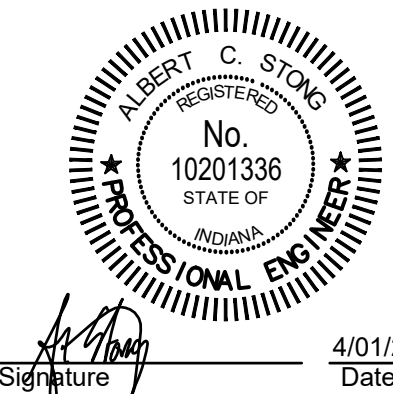

**CITY OF ROCHESTER
FULTON COUNTY, INDIANA
LEAD SERVICE LINE
REPLACEMENT PROJECT - DAC
AREA**

© 2023 BY COMMONWEALTH
ENGINEERS, INC. ALL RIGHTS
RESERVED. REPRODUCTION
BY ANY METHOD IN WHOLE
OR IN PART WITHOUT
PERMISSION IS PROHIBITED

Indiana 811
Know what's below. 811 before you dig.
1-800-382-5544
(IT'S THE LAW)

[illegible]

Designed By: AL	Drawn By: SSE	Checked By: RAL
Issue Date: SUBMITTAL	Project No: W24156	Scale: AS SHOWN

PLAN VIEW

Drawing No:

W4-03

FOR CONTINUATION SEE DWG W4-03


FOR CONTINUATION SEE DWG W3-04



FOR CONTINUATION SEE DWG W5-05

PLAN VIEW

SCALE: 1"=20'-0"

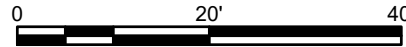


FOR CONTINUATION SEE DWG W4-05

COMMONWEALTH
ENGINEERS, INC.

A wealth of resources to master a common goal.

OFFICE LOCATIONS IN:

INDIANAPOLIS, IN. (2)
 EVANSVILLE, IN.
 FORT WAYNE, IN.
 CROWN POINT, IN.
 BOWLING GREEN, KY.
 SOUTH BEND, IN.

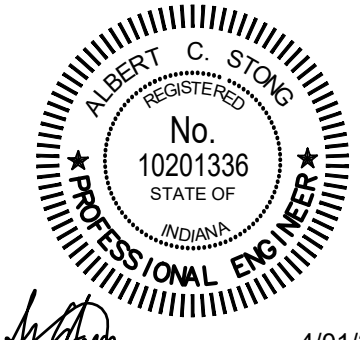

Signature _____ Date 4/01/2025

**CITY OF ROCHESTER
FULTON COUNTY, INDIANA
LEAD SERVICE LINE
REPLACEMENT PROJECT - DAC
AREA**

ENGINEERS, INC. ALL RIGHTS
RESERVED. REPRODUCTION
BY ANY METHOD IN WHOLE
OR IN PART WITHOUT
PERMISSION IS PROHIBITED

Indiana 811
Know what's below. 811 before you dig.
1-800-382-5544
(IT'S THE LAW)

[illegible]

Designed By: AL	Drawn By: SSE	Checked By: RAL
Issue Date: BMITTAL	Project No: W24156	Scale: AS SHOWN

PLAN VIEW

Drawing No:

W4-04


Sheet: 34 OF 86



FOR CONTINUATION SEE DWG W5-05

PLAN VIEW


SCALE: 1"=20'-0"

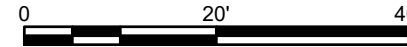

PROPOSED PLAN NOTES:

- ① CONTRACTOR SHALL VERIFY THE EXISTING SERVICE LINE MATERIAL TO BE EITHER LEAD OR GALVANIZED PRIOR TO REPLACING THE SERVICE LINE. CONTRACTOR SHALL POTHOLE THE CITY-OWNED SIDE OF THE SERVICE LINE A MINIMUM OF 3 FT BACK FROM CURB STOP.
- ② NEW 1" WATER SERVICE AND CURB STOP OR METER PIT
- ③ NEW 1-1/2" WATER SERVICE AND CURB STOP OR METER PIT
- ④ CURB STOP AND/OR METER PIT IS SHOWN FOR REPLACEMENT AND COULD NOT BE LOCATED IN THE FIELD. CONTRACTOR SHALL LOCATE PRIOR TO REPLACEMENT.
- ⑤ CONTRACTOR SHALL DISCONNECT EXISTING SERVICE LINE AT WATER MAIN AND ABANDON. EXISTING SERVICE LINE SHALL BE CUT AND CRIMPED. SERVICE LINE SHALL NOT BE REPLACED SINCE LOT IS EMPTY.

FOR CONTINUATION SEE DWG W4-06

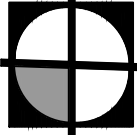

COMMONWEALTHTM
ENGINEERS, INC.
A wealth of resources to master a common goal.

<https://commonwealthengineers.com/>



Signature

4/01/2025
Date

**CITY OF ROCHESTER
FULTON COUNTY, INDIANA
LEAD SERVICE LINE
REPLACEMENT PROJECT - DAC
AREA**

© 2023 BY COMMONWEALTH ENGINEERS, INC. ALL RIGHTS RESERVED. REPRODUCTION BY ANY METHOD IN WHOLE OR IN PART WITHOUT PERMISSION IS PROHIBITED



Know what's below. 811 before you dig.
1-800-382-5544
(ITS THE LAW)

[illegible]

Designed By: AL	Drawn By: SSE	Checked By: RAL
--------------------	------------------	--------------------


Issue Date: SUBMITTAL	Project No: W24156	Scale: AS SHOWN
--------------------------	-----------------------	--------------------

PLAN VIEW

Drawing No:

W4-05

Sheet: 35 OF 86

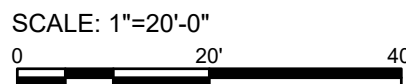

- ① CONTRACTOR SHALL VERIFY THE EXISTING SERVICE LINE MATERIAL TO BE EITHER LEAD OR GALVANIZED PRIOR TO REPLACING THE SERVICE LINE. CONTRACTOR SHALL POTHOLE THE CITY-OWNED SIDE OF THE SERVICE LINE A MINIMUM OF 3 FT BACK FROM CURB STOP.
- ② NEW 1" WATER SERVICE AND CURB STOP OR METER PIT
- ③ NEW 1-1/2" WATER SERVICE AND CURB STOP OR METER PIT
- ④ CURB STOP AND/OR METER PIT IS SHOWN FOR REPLACEMENT AND COULD NOT BE LOCATED IN THE FIELD. CONTRACTOR SHALL LOCATE PRIOR TO REPLACEMENT.
- ⑤ CONTRACTOR SHALL DISCONNECT EXISTING SERVICE LINE AT WATER MAIN AND ABANDON. EXISTING SERVICE LINE SHALL BE CUT AND CRIMPED. SERVICE LINE SHALL NOT BE REPLACED SINCE LOT IS EMPTY.


FOR CONTINUATION SEE DWG W5-08



FOR CONTINUATION SEE DWG W5-08

SCALE: 1"=20'-0"

SCALE: 1"=20'-0"

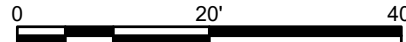

PROPOSED PLAN NOTES:


- ① CONTRACTOR SHALL VERIFY THE EXISTING SERVICE LINE MATERIAL TO BE EITHER LEAD OR GALVANIZED PRIOR TO REPLACING THE SERVICE LINE. CONTRACTOR SHALL POTHOLE THE CITY-OWNED SIDE OF THE SERVICE LINE A MINIMUM OF 3 FT BACK FROM CURB STOP.
- ② NEW 1" WATER SERVICE AND CURB STOP OR METER PIT
- ③ NEW 1-1/2" WATER SERVICE AND CURB STOP OR METER PIT
- ④ CURB STOP AND/OR METER PIT IS SHOWN FOR REPLACEMENT AND COULD NOT BE LOCATED IN THE FIELD. CONTRACTOR SHALL LOCATE PRIOR TO REPLACEMENT.
- ⑤ CONTRACTOR SHALL DISCONNECT EXISTING SERVICE LINE AT WATER MAIN AND ABANDON. EXISTING SERVICE LINE SHALL BE CUT AND CRIMPED. SERVICE LINE SHALL NOT BE REPLACED SINCE LOT IS EMPTY.



COMMONWEALTHTM
ENGINEERS, INC.
 A wealth of resources to master a common goal.

<https://commonwealthengineers.com/>

OFFICE LOCATIONS IN:
INDIANAPOLIS, IN. (2)
EVANSVILLE, IN.
FORT WAYNE, IN.
CROWN POINT, IN.
BOWLING GREEN, KY.
SOUTH BEND, IN.

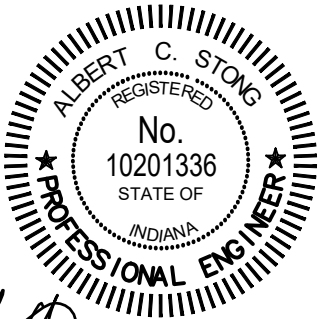

Signature

4/01/2025
Date

**CITY OF ROCHESTER
FULTON COUNTY, INDIANA
LEAD SERVICE LINE
REPLACEMENT PROJECT - DAC
AREA**

© 2023 BY COMMONWEALTH
ENGINEERS, INC. ALL RIGHTS
RESERVED. REPRODUCTION
BY ANY METHOD IN WHOLE
OR IN PART WITHOUT
PERMISSION IS PROHIBITED



Know what's below. 811 before you dig.
1-800-382-5544
(ITS THE LAW)

[illegible]

Designed By: AL	Drawn By: SSE	Checked By: RAL
Issue Date: SUBMITTAL	Project No: W24156	Scale: AS SHOWN

PLAN VIEW

Drawing No:

W4-07

Sheet: 37 OF 86

FOR CONTINUATION SEE DWG W4-07

FOR CONTINUATION SEE DWG W3-08

FOR CONTINUATION SEE DWG W5-09

FOR CONTINUATION SEE DWG W4-09




PLAN VIEW

SCALE: 1"=20'-0"
0 20' 40'

PROPOSED PLAN NOTES:

- CONTRACTOR SHALL VERIFY THE EXISTING SERVICE LINE MATERIAL TO BE EITHER LEAD OR GALVANIZED PRIOR TO REPLACING THE SERVICE LINE. CONTRACTOR SHALL POTHOLE THE CITY-OWNED SIDE OF THE SERVICE LINE A MINIMUM OF 3 FT BACK FROM CURB STOP.
- NEW 1" WATER SERVICE AND CURB STOP OR METER PIT
- NEW 1-1/2" WATER SERVICE AND CURB STOP OR METER PIT
- CURB STOP AND/OR METER PIT IS SHOWN FOR REPLACEMENT AND COULD NOT BE LOCATED IN THE FIELD. CONTRACTOR SHALL LOCATE PRIOR TO REPLACEMENT.
- CONTRACTOR SHALL DISCONNECT EXISTING SERVICE LINE AT WATER MAIN AND ABANDON. EXISTING SERVICE LINE SHALL BE CUT AND CRIMPED. SERVICE LINE SHALL NOT BE REPLACED SINCE LOT IS EMPTY.

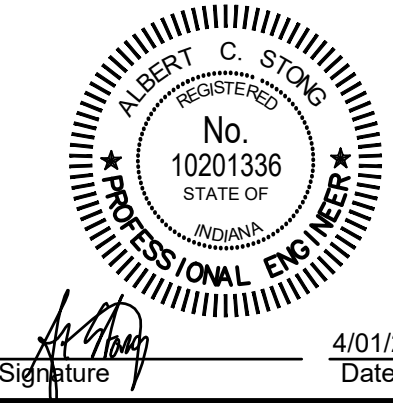

Signature: [Signature] Date: 4/01/2025

CITY OF ROCHESTER
FULTON COUNTY, INDIANA
LEAD SERVICE LINE
REPLACEMENT PROJECT - DAC
AREA

© 2023 BY COMMONWEALTH ENGINEERS, INC. ALL RIGHTS RESERVED. REPRODUCTION BY ANY METHOD IN WHOLE OR IN PART WITHOUT PERMISSION IS PROHIBITED.
Indiana 811
Know what's below. 811 before you dig.
1-800-382-5544
(IT'S THE LAW)

No.	Submittal / Revision	By	Date

Designed By: AL	Drawn By: SSE	Checked By: RAL
Issue Date: SUBMITTAL	Project No: W24156	Scale: AS SHOWN

PLAN VIEW


Drawing No:
W4-08
Sheet: 38 OF 86



FOR CONTINUATION SEE DWG W5-10

PLAN VIEW

SCALE: 1"=20'-0"

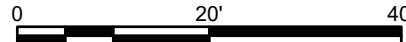


PROPOSED PLAN NOTES:

- ① CONTRACTOR SHALL VERIFY THE EXISTING SERVICE LINE MATERIAL TO BE EITHER LEAD OR GALVANIZED PRIOR TO REPLACING THE SERVICE LINE. CONTRACTOR SHALL POTHOLE THE CITY-OWNED SIDE OF THE SERVICE LINE A MINIMUM OF 3 FT BACK FROM CURB STOP.
- ② NEW 1" WATER SERVICE AND CURB STOP OR METER PIT
- ③ NEW 1-1/2" WATER SERVICE AND CURB STOP OR METER PIT
- ④ CURB STOP AND/OR METER PIT IS SHOWN FOR REPLACEMENT AND COULD NOT BE LOCATED IN THE FIELD. CONTRACTOR SHALL LOCATE PRIOR TO REPLACEMENT.
- ⑤ CONTRACTOR SHALL DISCONNECT EXISTING SERVICE LINE AT WATER MAIN AND ABANDON. EXISTING SERVICE LINE SHALL BE CUT AND CRIMPED. SERVICE LINE SHALL NOT BE REPLACED SINCE LOT IS EMPTY.



COMMONWEALTHTM
ENGINEERS, INC.
 A wealth of resources to master a common goal.



Signature _____

Date 4/01/2014

CITY OF ROCHESTER
FULTON COUNTY, INDIANA
LEAD SERVICE LINE
REPLACEMENT PROJECT - DAGE
AREA

© 2023 BY COMMONWEALTH ENGINEERS, INC. ALL RIGHTS RESERVED. REPRODUCTION BY ANY METHOD IN WHOLE OR IN PART WITHOUT PERMISSION IS PROHIBITED

[illegible]

Designed By: AL	Drawn By: SSE	Checked By: RAL
Issue Date: SUBMITTAL	Project No: W24156	Scale: AS SHOWN

PLAN VIEW

Drawing No:

W4-09

Sheet: 39 OF 86

FILE Z:\SHARED\IN\CLIENTS\IN\ROCHESTER\0041581\B REPLACEMENT PROJECT\DWG\AREA05-PLAN AND PLAN-JEFFERSON ST DRAWINGS.DWG
Sheet: 4/12/2025 1:12:13 PM Printed: 4/12/2025 3:43:37 PM Current User: Sam Exchange User: samexchange

PROPOSED PLAN NOTES:

- 1 CONTRACTOR SHALL VERIFY THE EXISTING SERVICE LINE MATERIAL TO BE EITHER LEAD OR GALVANIZED PRIOR TO REPLACING THE SERVICE LINE. CONTRACTOR SHALL POTHOLE THE CITY-OWNED SIDE OF THE SERVICE LINE A MINIMUM OF 3 FT BACK FROM CURB STOP.
- 2 NEW 1" WATER SERVICE AND CURB STOP OR METER PIT
- 3 NEW 1-1/2" WATER SERVICE AND CURB STOP OR METER PIT
- 4 CURB STOP AND/OR METER PIT IS SHOWN FOR REPLACEMENT AND COULD NOT BE LOCATED IN THE FIELD. CONTRACTOR SHALL LOCATE PRIOR TO REPLACEMENT.
- 5 CONTRACTOR SHALL DISCONNECT EXISTING SERVICE LINE AT WATER MAIN AND ABANDON. EXISTING SERVICE LINE SHALL BE CUT AND CRIMPED. SERVICE LINE SHALL NOT BE REPLACED SINCE LOT IS EMPTY.

FOR CONTINUATION SEE DWG W4-10





FOR CONTINUATION SEE DWG W4-12

FOR CONTINUATION SEE DWG W5-12

PLAN VIEW

SCALE: 1"=20'-0"

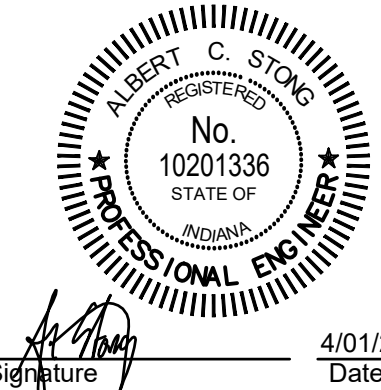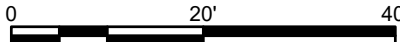

CITY OF ROCHESTER
FULTON COUNTY, INDIANA
LEAD SERVICE LINE
REPLACEMENT PROJECT - DAC
AREA

© 2023 BY COMMONWEALTH ENGINEERS, INC. ALL RIGHTS RESERVED. REPRODUCTION BY ANY METHOD IN WHOLE OR IN PART WITHOUT PERMISSION IS PROHIBITED.
Indiana 811
Know what's below. 811 before you dig.
1-800-382-5544
(IT'S THE LAW)

No.	Submittal / Revision	By	Date

Designed By: AL	Drawn By: SSE	Checked By: RAL
Issue Date: SUBMITTAL	Project No: W24156	Scale: AS SHOWN

PLAN VIEW

Drawing No:
W4-11
Sheet: 41 OF 86


FOR CONTINUATION SEE DWG W4-11



FOR CONTINUATION SEE DWG W5-13


PLAN VIEW

SCALE: 1"=20'-0"

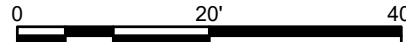

PROPOSED PLAN NOTES:

- CONTRACTOR SHALL VERIFY THE EXISTING SERVICE LINE MATERIAL TO BE EITHER LEAD OR GALVANIZED PRIOR TO REPLACING THE SERVICE LINE. CONTRACTOR SHALL POTHOLE THE CITY-OWNED SIDE OF THE SERVICE LINE A MINIMUM OF 3 FT BACK FROM CURB STOP.
- NEW 1" WATER SERVICE AND CURB STOP OR METER PIT
- NEW 1-1/2" WATER SERVICE AND CURB STOP OR METER PIT
- CURB STOP AND/OR METER PIT IS SHOWN FOR REPLACEMENT AND COULD NOT BE LOCATED IN THE FIELD. CONTRACTOR SHALL LOCATE PRIOR TO REPLACEMENT.
- CONTRACTOR SHALL DISCONNECT EXISTING SERVICE LINE AT WATER MAIN AND ABANDON. EXISTING SERVICE LINE SHALL BE CUT AND CRIMPED. SERVICE LINE SHALL NOT BE REPLACED SINCE LOT IS EMPTY.

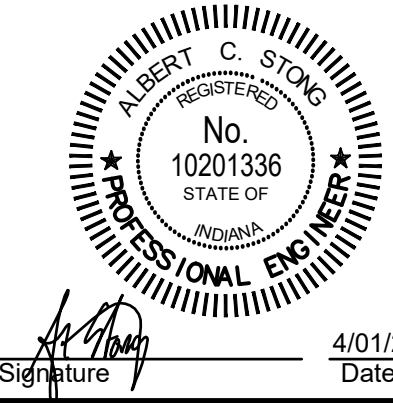

Signature: *Albert C. Stong* Date: 4/01/2025

CITY OF ROCHESTER
FULTON COUNTY, INDIANA
LEAD SERVICE LINE
REPLACEMENT PROJECT - DAC
AREA

© 2023 BY COMMONWEALTH ENGINEERS, INC. ALL RIGHTS RESERVED. REPRODUCTION BY ANY METHOD IN WHOLE OR IN PART WITHOUT PERMISSION IS PROHIBITED.
Indiana 811
Know what's below. 811 before you dig.
1-800-382-5544
(IT'S THE LAW)

No.	Submital / Revision	By	Date

Designed By: AL	Drawn By: SSE	Checked By: RAL
Issue Date: SUBMITTAL	Project No: W24156	Scale: AS SHOWN

PLAN VIEW

Drawing No:
W4-12
Sheet: 42 OF 86



PLAN VIEW


SCALE: 1"=20'-0"
0 20' 40'

PROPOSED PLAN NOTES:

- CONTRACTOR SHALL VERIFY THE EXISTING SERVICE LINE MATERIAL TO BE EITHER LEAD OR GALVANIZED PRIOR TO REPLACING THE SERVICE LINE. CONTRACTOR SHALL POT-HOLE THE CITY-OWNED SIDE OF THE SERVICE LINE A MINIMUM OF 3 FT BACK FROM CURB STOP.
- NEW 1" WATER SERVICE AND CURB STOP OR METER PIT
- NEW 1-1/2" WATER SERVICE AND CURB STOP OR METER PIT
- CURB STOP AND/OR METER PIT IS SHOWN FOR REPLACEMENT AND COULD NOT BE LOCATED IN THE FIELD. CONTRACTOR SHALL LOCATE PRIOR TO REPLACEMENT.
- CONTRACTOR SHALL DISCONNECT EXISTING SERVICE LINE AT WATER MAIN AND ABANDON. EXISTING SERVICE LINE SHALL BE CUT AND CRIMPED. SERVICE LINE SHALL NOT BE REPLACED SINCE LOT IS EMPTY.



COMMONWEALTH
ENGINEERS, INC.
A LIMITED LIABILITY CORPORATION
OFFICE LOCATIONS IN:
INDIANAPOLIS, IN (2)
EVANSVILLE, IN
FORT WAYNE, IN
CROWN POINT, IN
BOWLING GREEN, KY
SOUTH BEND, IN
<https://commonwealthengineers.com/>

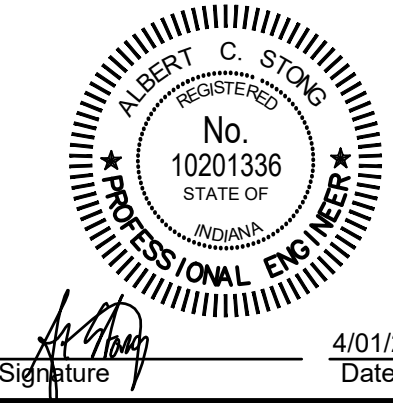

Signature: *[Signature]* Date: 4/01/2025

CITY OF ROCHESTER
FULTON COUNTY, INDIANA
LEAD SERVICE LINE
REPLACEMENT PROJECT - DAC
AREA

© 2023 BY COMMONWEALTH ENGINEERS, INC. ALL RIGHTS RESERVED. REPRODUCTION BY ANY METHOD IN WHOLE OR IN PART WITHOUT PERMISSION IS PROHIBITED.




No.	Submital / Revision	By	Date


Designed By: AL	Drawn By: SSE	Checked By: RAL
Issue Date: SUBMITTAL	Project No: W24156	Scale: AS SHOWN

PLAN VIEW		
Drawing No: W5-01		
Sheet:	43	OF 86

FOR CONTINUATION SEE DWG W6-01

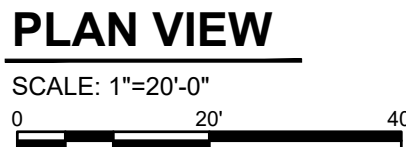

- ① CONTRACTOR SHALL VERIFY THE EXISTING SERVICE LINE MATERIAL TO BE EITHER LEAD OR GALVANIZED PRIOR TO REPLACING THE SERVICE LINE. CONTRACTOR SHALL POTHOLE THE CITY-OWNED SIDE OF THE SERVICE LINE A MINIMUM OF 3 FT BACK FROM CURB STOP.
- ② NEW 1" WATER SERVICE AND CURB STOP OR METER PIT
- ③ NEW 1-1/2" WATER SERVICE AND CURB STOP OR METER PIT
- ④ CURB STOP AND/OR METER PIT IS SHOWN FOR REPLACEMENT AND COULD NOT BE LOCATED IN THE FIELD. CONTRACTOR SHALL LOCATE PRIOR TO REPLACEMENT.
- ⑤ CONTRACTOR SHALL DISCONNECT EXISTING SERVICE LINE AT WATER MAIN AND ABANDON. EXISTING SERVICE LINE SHALL BE CUT AND CRIMPED. SERVICE LINE SHALL NOT BE REPLACED SINCE LOT IS EMPTY.



Signature _____

Date 4/01/2014

© 2023 BY COMMONWEALTH ENGINEERS, INC. ALL RIGHTS RESERVED. REPRODUCTION BY ANY METHOD IN WHOLE OR IN PART WITHOUT PERMISSION IS PROHIBITED

Indiana 811

Know what's below. 811 before you dig

1-800-382-5544
(IT'S THE LAW)

Designed By: AL	Drawn By: SSE	Checked By: RAL
Issue Date: SUBMITTAL	Project No: W24156	Scale: AS SHOWN

Drawing No:

Sheet: 44 OF 86


FOR CONTINUATION SEE DWG W4-02



FOR CONTINUATION SEE DWG W6-02

PLAN VIEW

SCALE: 1"=20'-0"

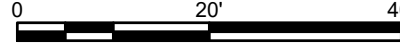

PROPOSED PLAN NOTES


- ① CONTRACTOR SHALL VERIFY THE EXISTING SERVICE LINE MATERIAL TO BE EITHER LEAD OR GALVANIZED PRIOR TO REPLACING THE SERVICE LINE. CONTRACTOR SHALL POTHOLE THE CITY-OWNED SIDE OF THE SERVICE LINE A MINIMUM OF 3 FT BACK FROM CURB STOP.
- ② NEW 1" WATER SERVICE AND CURB STOP OR METER PIT
- ③ NEW 1-1/2" WATER SERVICE AND CURB STOP OR METER PIT
- ④ CURB STOP AND/OR METER PIT IS SHOWN FOR REPLACEMENT AND COULD NOT BE LOCATED IN THE FIELD. CONTRACTOR SHALL LOCATE PRIOR TO REPLACEMENT.
- ⑤ CONTRACTOR SHALL DISCONNECT EXISTING SERVICE LINE AT WATER MAIN AND ABANDON. EXISTING SERVICE LINE SHALL BE CUT AND CRIMPED. SERVICE LINE SHALL NOT BE REPLACED SINCE LOT IS EMPTY.



COMMONWEALTHTM
ENGINEERS, INC.
 A wealth of resources to master a common goal.

OFFICE LOCATIONS IN:
INDIANAPOLIS, IN. (2)
EVANSVILLE, IN.
FORT WAYNE, IN.
CROWN POINT, IN.
BOWLING GREEN, KY.
SOUTH BEND, IN.

<https://commonwealthengineers.com/>

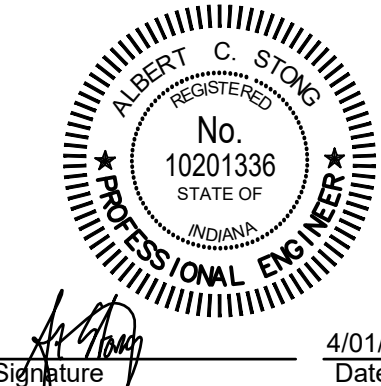

Signature

4/01/2025
Date

**CITY OF ROCHESTER
FULTON COUNTY, INDIANA
LEAD SERVICE LINE
REPLACEMENT PROJECT - DAC
AREA**

© 2023 BY COMMONWEALTH ENGINEERS, INC. ALL RIGHTS RESERVED. REPRODUCTION BY ANY METHOD IN WHOLE OR IN PART WITHOUT PERMISSION IS PROHIBITED



Know what's below. 811 before you dig.

[illegible]


Designed By: AL	Drawn By: SSE	Checked By: RAL
Issue Date: SUBMITTAL	Project No: W24156	Scale: AS SHOWN

PLAN VIEW


Drawing No:

W5-03

Sheet: 45 OF 86

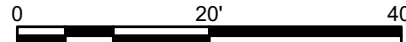

- ① CONTRACTOR SHALL VERIFY THE EXISTING SERVICE LINE MATERIAL TO BE EITHER LEAD OR GALVANIZED PRIOR TO REPLACING THE SERVICE LINE. CONTRACTOR SHALL POTHOLE THE CITY-OWNED SIDE OF THE SERVICE LINE A MINIMUM OF 3 FT BACK FROM CURB STOP.
- ② NEW 1" WATER SERVICE AND CURB STOP OR METER PIT
- ③ NEW 1-1/2" WATER SERVICE AND CURB STOP OR METER PIT
- ④ CURB STOP AND/OR METER PIT IS SHOWN FOR REPLACEMENT AND COULD NOT BE LOCATED IN THE FIELD. CONTRACTOR SHALL LOCATE PRIOR TO REPLACEMENT.
- ⑤ CONTRACTOR SHALL DISCONNECT EXISTING SERVICE LINE AT WATER MAIN AND ABANDON. EXISTING SERVICE LINE SHALL BE CUT AND CRIMPED. SERVICE LINE SHALL NOT BE REPLACED SINCE LOT IS EMPTY.

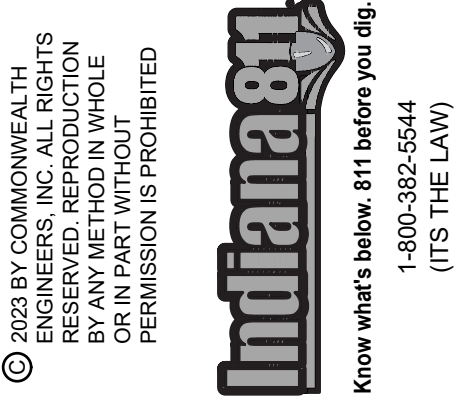

Designed By: AL	Drawn By: SSE	Checked By: RAL
Issue Date: SUBMITTAL	Project No: W24156	Scale: AS SHOWN


W5-04

FOR CONTINUATION SEE DWG W6-04



SCALE: 1"=20'-0"

- ① CONTRACTOR SHALL VERIFY THE EXISTING SERVICE LINE MATERIAL TO BE EITHER LEAD OR GALVANIZED PRIOR TO REPLACING THE SERVICE LINE. CONTRACTOR SHALL POTHOLE THE CITY-OWNED SIDE OF THE SERVICE LINE A MINIMUM OF 3 FT BACK FROM CURB STOP.
- ② NEW 1" WATER SERVICE AND CURB STOP OR METER PIT
- ③ NEW 1-1/2" WATER SERVICE AND CURB STOP OR METER PIT
- ④ CURB STOP AND/OR METER PIT IS SHOWN FOR REPLACEMENT AND COULD NOT BE LOCATED IN THE FIELD. CONTRACTOR SHALL LOCATE PRIOR TO REPLACEMENT.
- ⑤ CONTRACTOR SHALL DISCONNECT EXISTING SERVICE LINE AT WATER MAIN AND ABANDON. EXISTING SERVICE LINE SHALL BE CUT AND CRIMPED. SERVICE LINE SHALL NOT BE REPLACED SINCE LOT IS EMPTY.

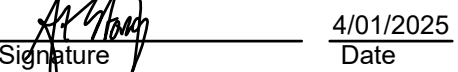

**CITY OF ROCHESTER
FULTON COUNTY, INDIANA
LEAD SERVICE LINE
REPLACEMENT PROJECT - DAC
AREA**

© 2023 BY COMMONWEALTH
ENGINEERS, INC. ALL RIGHTS
RESERVED. REPRODUCTION
BY ANY METHOD IN WHOLE
OR IN PART WITHOUT
PERMISSION IS PROHIBITED

Indiana811

[illegible]

Designed By: AL	Drawn By: SSE	Checked By: RAL
Issue Date: SUBMITTAL	Project No: W24156	Scale: AS SHOWN

PLAN VIEW

FILE OF

WV 5-05

Sheet: 47 OF 86

FOR CONTINUATION SEE DWG W6-05



CONTRACTOR SHALL VERIFY THE EXISTING SERVICE LINE MATERIAL TO BE EITHER LEAD OR GALVANIZED PRIOR TO REPLACING THE SERVICE LINE. CONTRACTOR SHALL POTHOLE THE CITY-OWNED SIDE OF THE SERVICE LINE A MINIMUM OF 3 FT BACK FROM CURB STOP.

NEW 1" WATER SERVICE AND CURB STOP OR METER PIT

NEW 1-1/2" WATER SERVICE AND CURB STOP OR METER PIT


CURB STOP AND/OR METER PIT IS SHOWN FOR REPLACEMENT AND COULD NOT BE LOCATED IN THE FIELD. CONTRACTOR SHALL LOCATE PRIOR TO REPLACEMENT.

CONTRACTOR SHALL DISCONNECT EXISTING SERVICE LINE AT WATER MAIN AND ABANDON. EXISTING SERVICE LINE SHALL BE CUT AND CRIMPED. SERVICE LINE SHALL NOT BE REPLACED SINCE LOT IS EMPTY.

SCALE: 1"=20'-0"



OFFICE LOCATIONS IN:
INDIANAPOLIS, IN. (2)
EVANSVILLE, IN.
FORT WAYNE, IN.
CROWN POINT, IN.
BOWLING GREEN, KY.
SOUTH BEND, IN.

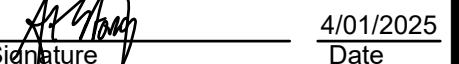

© 2023 BY COMMONWEALTH ENGINEERS, INC. ALL RIGHTS RESERVED. REPRODUCTION BY ANY METHOD IN WHOLE OR IN PART WITHOUT PERMISSION IS PROHIBITED

Indiana 811

Know what's below. 811 before you dig

1-800-382-5544
(IT'S THE LAW)


Designed By: AL	Drawn By: SSE	Checked By: RAL
Issue Date: SUBMITTAL	Project No: W24156	Scale: AS SHOWN

Drawing No:


N5-06

Sheet: 48 OF 86

FOR CONTINUATION SEE DWG W6-06

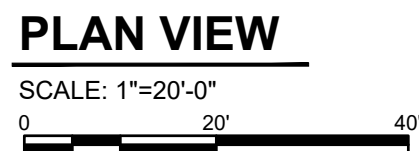

- ① CONTRACTOR SHALL VERIFY THE EXISTING SERVICE LINE MATERIAL TO BE EITHER LEAD OR GALVANIZED PRIOR TO REPLACING THE SERVICE LINE. CONTRACTOR SHALL POTHOLE THE CITY-OWNED SIDE OF THE SERVICE LINE A MINIMUM OF 3 FT BACK FROM CURB STOP.
- ② NEW 1" WATER SERVICE AND CURB STOP OR METER PIT
- ③ NEW 1-1/2" WATER SERVICE AND CURB STOP OR METER PIT
- ④ CURB STOP AND/OR METER PIT IS SHOWN FOR REPLACEMENT AND COULD NOT BE LOCATED IN THE FIELD. CONTRACTOR SHALL LOCATE PRIOR TO REPLACEMENT.
- ⑤ CONTRACTOR SHALL DISCONNECT EXISTING SERVICE LINE AT WATER MAIN AND ABANDON. EXISTING SERVICE LINE SHALL BE CUT AND CRIMPED. SERVICE LINE SHALL NOT BE REPLACED SINCE LOT IS EMPTY.

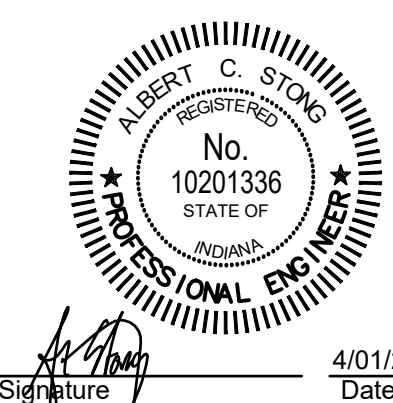

© 2023 BY COMMONWEALTH ENGINEERS, INC. ALL RIGHTS RESERVED. REPRODUCTION BY ANY METHOD IN WHOLE OR IN PART WITHOUT



Know what's below. 811 before you dig.
1-800-382-5544
(ITS THE LAW)

[illegible]

Designed By: AL	Drawn By: SSE	Checked By: RAL
Issue Date: SUBMITTAL	Project No: W24156	Scale: AS SHOWN

PLAN VIEW

Drawing No:

W5-07



CONTRACTOR SHALL DISCONNECT EXISTING SERVICE LINE AT WATER MAIN AND ABANDON. EXISTING SERVICE LINE SHALL BE CUT AND CRIMPED. SERVICE LINE SHALL NOT BE REPLACED SINCE LOT IS EMPTY.

Sheet: 50 OF 86

PROPOSED PLAN NOTES:

- 1 CONTRACTOR SHALL VERIFY THE EXISTING SERVICE LINE MATERIAL TO BE EITHER LEAD OR GALVANIZED PRIOR TO REPLACING THE SERVICE LINE. CONTRACTOR SHALL POTHOLE THE CITY-OWNED SIDE OF THE SERVICE LINE A MINIMUM OF 3 FT BACK FROM CURB STOP.
- 2 NEW 1" WATER SERVICE AND CURB STOP OR METER PIT
- 3 NEW 1-1/2" WATER SERVICE AND CURB STOP OR METER PIT
- 4 CURB STOP AND/OR METER PIT IS SHOWN FOR REPLACEMENT AND COULD NOT BE LOCATED IN THE FIELD. CONTRACTOR SHALL LOCATE PRIOR TO REPLACEMENT.
- 5 CONTRACTOR SHALL DISCONNECT EXISTING SERVICE LINE AT WATER MAIN AND ABANDON. EXISTING SERVICE LINE SHALL BE CUT AND CRIMPED. SERVICE LINE SHALL NOT BE REPLACED SINCE LOT IS EMPTY.


FOR CONTINUATION SEE DWG W5-08



FOR CONTINUATION SEE DWG W6-08

PLAN VIEW

SCALE: 1"=20'-0"

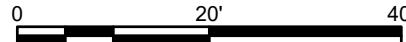

FOR CONTINUATION SEE DWG W5-10



OFFICE LOCATIONS IN:
INDIANAPOLIS, IN (2)
EVANSVILLE, IN
FORT WAYNE, IN
CROWN POINT, IN
BOWLING GREEN, KY
SOUTH BEND, IN



Signature: [Signature] Date: 4/01/2025

CITY OF ROCHESTER
FULTON COUNTY, INDIANA
LEAD SERVICE LINE
REPLACEMENT PROJECT - DAC
AREA

© 2023 BY COMMONWEALTH ENGINEERS, INC. ALL RIGHTS RESERVED. REPRODUCTION BY ANY METHOD IN WHOLE OR IN PART WITHOUT PERMISSION IS PROHIBITED.



No.	Submitted / Revision	By	Date

Designed By: AL	Drawn By: SSE	Checked By: RAL
Issue Date: SUBMITTAL	Project No: W24156	Scale: AS SHOWN

PLAN VIEW

Drawing No:

W5-09

Sheet: 51 OF 86

FOR CONTINUATION SEE DWG W5-09


FOR CONTINUATION SEE DWG W4-09



FOR CONTINUATION SEE DWG W6-09

PLAN VIEW

SCALE: 1"=20'-0"

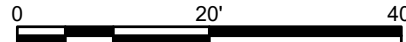

FOR CONTINUATION SEE DWG W5-11

**CITY OF ROCHESTER
FULTON COUNTY, INDIANA
LEAD SERVICE LINE
REPLACEMENT PROJECT - DAC
AREA**

© 2023 BY COMMONWEALTH ENGINEERS, INC. ALL RIGHTS RESERVED. REPRODUCTION BY ANY METHOD IN WHOLE OR IN PART WITHOUT PERMISSION IS PROHIBITED

Indiana 811
Know what's below. 811 before you dig.
1-800-382-5544
(ITS THE LAW)

[illegible]

Designed By: AL	Drawn By: SSE	Checked By: RAL
Issue Date: SUBMITTAL	Project No: W24156	Scale: AS SHOWN

PLAN VIEW


Drawing No:

W5-10

Sheet: 52 OF 86



COMMONWEALTHTM
ENGINEERS, INC.
A wealth of resources to master a common goal.

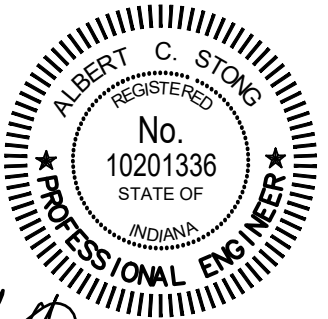

Signature

4/01/2025
Date

FOR CONTINUATION SEE DWG W5-10



PLAN VIEW

SCALE: 1"=20'-0"
0 20' 40'

PROPOSED PLAN NOTES:

- 1 CONTRACTOR SHALL VERIFY THE EXISTING SERVICE LINE MATERIAL TO BE EITHER LEAD OR GALVANIZED PRIOR TO REPLACING THE SERVICE LINE. CONTRACTOR SHALL POTHOLE THE CITY-OWNED SIDE OF THE SERVICE LINE A MINIMUM OF 3 FT BACK FROM CURB STOP.
- 2 NEW 1" WATER SERVICE AND CURB STOP OR METER PIT
- 3 NEW 1-1/2" WATER SERVICE AND CURB STOP OR METER PIT
- 4 CURB STOP AND/OR METER PIT IS SHOWN FOR REPLACEMENT AND COULD NOT BE LOCATED IN THE FIELD. CONTRACTOR SHALL LOCATE PRIOR TO REPLACEMENT.
- 5 CONTRACTOR SHALL DISCONNECT EXISTING SERVICE LINE AT WATER MAIN AND ABANDON. EXISTING SERVICE LINE SHALL BE CUT AND CRIMPED. SERVICE LINE SHALL NOT BE REPLACED SINCE LOT IS EMPTY.

FOR CONTINUATION SEE DWG W5-12

CITY OF ROCHESTER
FULTON COUNTY, INDIANA
LEAD SERVICE LINE
REPLACEMENT PROJECT - DAC
AREA

© 2023 BY COMMONWEALTH
ENGINEERS, INC. ALL RIGHTS
RESERVED. REPRODUCTION
BY ANY METHOD IN WHOLE
OR IN PART WITHOUT THE
PERMISSION IS PROHIBITED



No.	Submittal / Revision	By	Date

Designed By: AL	Drawn By: SSE	Checked By: RAL
Issue Date: SUBMITTAL	Project No: W24156	Scale: AS SHOWN

PLAN VIEW

Drawing No:

W5-11

Sheet: 53 OF 86



COMMONWEALTH
ENGINEERS, INC.
A member of the Commonwealth Engineering Group

https://commonwealthengineers.com/

OFFICE LOCATIONS IN:
INDIANAPOLIS, IN (2)
EVANSVILLE, IN
FORT WAYNE, IN
CROWN POINT, IN
BOWLING GREEN, KY
SOUTH BEND, IN



Signature

4/01/2025
Date


FOR CONTINUATION SEE DWG W6-10



PLAN VIEW

SCALE: 1"=20'-0"

- ① CONTRACTOR SHALL VERIFY THE EXISTING SERVICE LINE MATERIAL TO BE EITHER LEAD OR GALVANIZED PRIOR TO REPLACING THE SERVICE LINE. CONTRACTOR SHALL POTHOLE THE CITY-OWNED SIDE OF THE SERVICE LINE A MINIMUM OF 3 FT BACK FROM CURB STOP.
- ② NEW 1" WATER SERVICE AND CURB STOP OR METER PIT
- ③ NEW 1-1/2" WATER SERVICE AND CURB STOP OR METER PIT
- ④ CURB STOP AND/OR METER PIT IS SHOWN FOR REPLACEMENT AND COULD NOT BE LOCATED IN THE FIELD. CONTRACTOR SHALL LOCATE PRIOR TO REPLACEMENT.
- ⑤ CONTRACTOR SHALL DISCONNECT EXISTING SERVICE LINE AT WATER MAIN AND ABANDON. EXISTING SERVICE LINE SHALL BE CUT AND CRIMPED. SERVICE LINE SHALL NOT BE REPLACED SINCE LOT IS EMPT.



Signature _____ 4/01/2014
Date _____

© 2023 BY COMMONWEALTH ENGINEERS, INC. ALL RIGHTS RESERVED. REPRODUCTION BY ANY METHOD IN WHOLE OR IN PART WITHOUT PERMISSION IS PROHIBITED

Indiana811
Know what's below. 811 before you dig.
1-800-382-5544
(IT'S THE LAW)

[illegible]

Designed By: AL	Drawn By: SSE	Checked By: RAL
Issue Date: SUBMITTAL	Project No: W24156	Scale: AS SHOWN

PLAN VIEW

W5-12


Sheet: 54 OF 86

FOR CONTINUATION SEE DWG W4-12



PLAN VIEW

SCALE: 1"=20'-0"

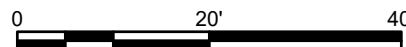**PROPOSED PLAN NOTES:**

- ① CONTRACTOR SHALL VERIFY THE EXISTING SERVICE LINE MATERIAL TO BE EITHER LEAD OR GALVANIZED PRIOR TO REPLACING THE SERVICE LINE. CONTRACTOR SHALL POTHOLE THE CITY-OWNED SIDE OF THE SERVICE LINE A MINIMUM OF 3 FT BACK FROM CURB STOP.
- ② NEW 1" WATER SERVICE AND CURB STOP OR METER PIT
- ③ NEW 1-1/2" WATER SERVICE AND CURB STOP OR METER PIT
- ④ CURB STOP AND/OR METER PIT IS SHOWN FOR REPLACEMENT AND COULD NOT BE LOCATED IN THE FIELD. CONTRACTOR SHALL LOCATE PRIOR TO REPLACEMENT.
- ⑤ CONTRACTOR SHALL DISCONNECT EXISTING SERVICE LINE AT WATER MAIN AND ABANDON. EXISTING SERVICE LINE SHALL BE CUT AND CRIMPED. SERVICE LINE SHALL NOT BE REPLACED SINCE LOT IS EMPTY.



COMMONWEALTHTM
ENGINEERS, INC.
 A wealth of resources to master a common goal.

<https://commonwealthengineers.com/>

OFFICE LOCATIONS IN:
INDIANAPOLIS, IN. (2)
EVANSVILLE, IN.
FORT WAYNE, IN.
CROWN POINT, IN.
BOWLING GREEN, KY.
SOUTH BEND, IN.

ALBERT C. STONG
REGISTERED
No.
10201336
STATE OF
INDIANA
PROFESSIONAL ENGINEER

Signature 4/01/2025
Date

**CITY OF ROCHESTER
FULTON COUNTY, INDIANA
LEAD SERVICE LINE
REPLACEMENT PROJECT - DAC
AREA**

© 2023 BY COMMONWEALTH ENGINEERS, INC. ALL RIGHTS RESERVED. REPRODUCTION BY ANY METHOD IN WHOLE OR IN PART WITHOUT PERMISSION IS PROHIBITED

Indiana811

Know what's below. 811 before you dig.
1-800-382-5544
(ITS THE LAW)

[illegible]

Designed By: AL	Drawn By: SSE	Checked By: RAL
Issue Date: SUBMITTAL	Project No: W24156	Scale: AS SHOWN

PLAN VIEW

Drawing No:

W5-13

Sheet: 55 OF 86


FOR CONTINUATION SEE DWG W7-02

SCALE: 1"=20'-0"

0 20' 40'

A horizontal scale bar with alternating black and white segments. It is marked with '0' at the left end, '20'' in the middle, and '40'' at the right end.

- ① CONTRACTOR SHALL VERIFY THE EXISTING SERVICE LINE MATERIAL TO BE EITHER LEAD OR GALVANIZED PRIOR TO REPLACING THE SERVICE LINE. CONTRACTOR SHALL POTHOLE THE CITY-OWNED SIDE OF THE SERVICE LINE A MINIMUM OF 3 FT BACK FROM CURB STOP.
- ② NEW 1" WATER SERVICE AND CURB STOP OR METER PIT
- ③ NEW 1-1/2" WATER SERVICE AND CURB STOP OR METER PIT
- ④ CURB STOP AND/OR METER PIT IS SHOWN FOR REPLACEMENT AND COULD NOT BE LOCATED IN THE FIELD. CONTRACTOR SHALL LOCATE PRIOR TO REPLACEMENT.
- ⑤ CONTRACTOR SHALL DISCONNECT EXISTING SERVICE LINE AT WATER MAIN AND ABANDON. EXISTING SERVICE LINE SHALL BE CUT AND CRIMPED. SERVICE LINE SHALL NOT BE REPLACED SINCE LOT IS EMPTY.



ALBERT C. STONG
REGISTERED
No.
10201336
STATE OF
INDIANA
PROFESSIONAL ENGINEER

4/01/1

© 2023 BY COMMONWEALTH ENGINEERS, INC. ALL RIGHTS RESERVED. REPRODUCTION BY ANY METHOD IN WHOLE OR IN PART WITHOUT PERMISSION IS PROHIBITED

Indiana 811

Know what's below. 811 before you dig.

1-800-382-5544
(ITS THE LAW)

Designed By: AL	Drawn By: SSE	Checked By: RAL
Issue Date: SUBMITTAL	Project No: W24156	Scale: AS SHOWN

Drawing No:

W6-01

Sheet: 56 OF 86

FOR CONTINUATION SEE DWG W6-01




PROPOSED PLAN NOTES:

- 1 CONTRACTOR SHALL VERIFY THE EXISTING SERVICE LINE MATERIAL TO BE EITHER LEAD OR GALVANIZED PRIOR TO REPLACING THE SERVICE LINE. CONTRACTOR SHALL POTHOLE THE CITY-OWNED SIDE OF THE SERVICE LINE A MINIMUM OF 3 FT BACK FROM CURB STOP.
- 2 NEW 1" WATER SERVICE AND CURB STOP OR METER PIT
- 3 NEW 1-1/2" WATER SERVICE AND CURB STOP OR METER PIT
- 4 CURB STOP AND/OR METER PIT IS SHOWN FOR REPLACEMENT AND COULD NOT BE LOCATED IN THE FIELD. CONTRACTOR SHALL LOCATE PRIOR TO REPLACEMENT.
- 5 CONTRACTOR SHALL DISCONNECT EXISTING SERVICE LINE AT WATER MAIN AND ABANDON. EXISTING SERVICE LINE SHALL BE CUT AND CRIMPED. SERVICE LINE SHALL NOT BE REPLACED SINCE LOT IS EMPTY.

FOR CONTINUATION SEE DWG W7-03

PLAN VIEW

SCALE: 1"=20'-0"

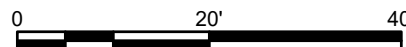

FOR CONTINUATION SEE DWG W6-03



OFFICE LOCATIONS IN:
INDIANAPOLIS, IN (2)
EVANSVILLE, IN
FORT WAYNE, IN
CROWN POINT, IN
BOWLING GREEN, KY
SOUTH BEND, IN



Signature: *Albert C. Stong* Date: 4/01/2025

**CITY OF ROCHESTER
FULTON COUNTY, INDIANA
LEAD SERVICE LINE
REPLACEMENT PROJECT - DAC
AREA**

© 2023 BY COMMONWEALTH ENGINEERS, INC. ALL RIGHTS RESERVED. REPRODUCTION BY ANY METHOD IN WHOLE OR IN PART WITHOUT PERMISSION IS PROHIBITED.
Indiana 811
Know what's below. 811 before you dig.
1-800-382-5544
(IT'S THE LAW)

No.	Submittal / Revision	By	Date

Designed By: AL	Drawn By: SSE	Checked By: RAL
Issue Date: SUBMITTAL	Project No: W24156	Scale: AS SHOWN

PLAN VIEW

Drawing No:

W6-02

Sheet: 57 OF 86

FOR CONTINUATION SEE DWG W6-02




PROPOSED PLAN NOTES:

- 1 CONTRACTOR SHALL VERIFY THE EXISTING SERVICE LINE MATERIAL TO BE EITHER LEAD OR GALVANIZED PRIOR TO REPLACING THE SERVICE LINE. CONTRACTOR SHALL POTHOLE THE CITY-OWNED SIDE OF THE SERVICE LINE A MINIMUM OF 3 FT BACK FROM CURB STOP.
- 2 NEW 1" WATER SERVICE AND CURB STOP OR METER PIT
- 3 NEW 1-1/2" WATER SERVICE AND CURB STOP OR METER PIT
- 4 CURB STOP AND/OR METER PIT IS SHOWN FOR REPLACEMENT AND COULD NOT BE LOCATED IN THE FIELD. CONTRACTOR SHALL LOCATE PRIOR TO REPLACEMENT.
- 5 CONTRACTOR SHALL DISCONNECT EXISTING SERVICE LINE AT WATER MAIN AND ABANDON. EXISTING SERVICE LINE SHALL BE CUT AND CRIMPED. SERVICE LINE SHALL NOT BE REPLACED SINCE LOT IS EMPTY.


FOR CONTINUATION SEE DWG W7-04

PLAN VIEW

SCALE: 1"=20'-0"

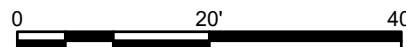

FOR CONTINUATION SEE DWG W6-04

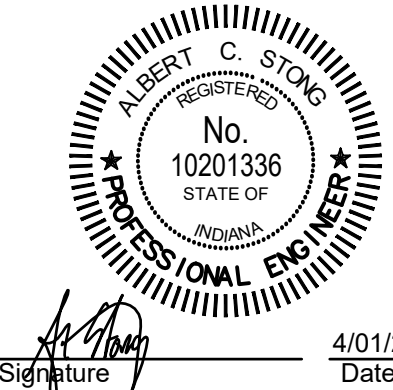

Signature: [Signature] Date: 4/01/2025

**CITY OF ROCHESTER
FULTON COUNTY, INDIANA
LEAD SERVICE LINE
REPLACEMENT PROJECT - DAC
AREA**

© 2023 BY COMMONWEALTH ENGINEERS, INC. ALL RIGHTS RESERVED. REPRODUCTION BY ANY METHOD IN WHOLE OR IN PART WITHOUT PERMISSION IS PROHIBITED.
Indiana 811
Know what's below. 811 before you dig.
1-800-382-5544
(IT'S THE LAW)

No.	Submital / Revision	By	Date

Designed By: AL	Drawn By: SSE	Checked By: RAL
Issue Date: SUBMITTAL	Project No: W24156	Scale: AS SHOWN

PLAN VIEW

Drawing No:

W6-03

Sheet: 58 OF 86

FOR CONTINUATION SEE DWG W7-05


SCALE: 1"=20'-0"



- ① CONTRACTOR SHALL VERIFY THE EXISTING SERVICE LINE MATERIAL TO BE EITHER LEAD OR GALVANIZED PRIOR TO REPLACING THE SERVICE LINE. CONTRACTOR SHALL POTHOLE THE CITY-OWNED SIDE OF THE SERVICE LINE A MINIMUM OF 3 FT BACK FROM CURB STOP.
- ② NEW 1" WATER SERVICE AND CURB STOP OR METER PIT
- ③ NEW 1-1/2" WATER SERVICE AND CURB STOP OR METER PIT
- ④ CURB STOP AND/OR METER PIT IS SHOWN FOR REPLACEMENT AND COULD NOT BE LOCATED IN THE FIELD. CONTRACTOR SHALL LOCATE PRIOR TO REPLACEMENT.
- ⑤ CONTRACTOR SHALL DISCONNECT EXISTING SERVICE LINE AT WATER MAIN AND ABANDON. EXISTING SERVICE LINE SHALL BE CUT AND CRIMPED. SERVICE LINE SHALL NOT BE REPLACED SINCE LOT IS EMPTY.



**COMMONWEALTH
ENGINEERS, INC.**
A wealth of resources to master a common goal.

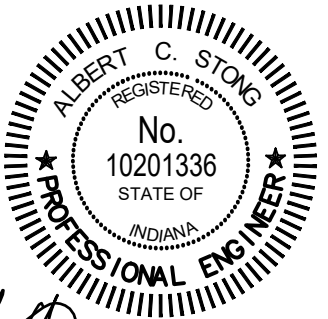

Signature 4/01/2025
Date

CITY OF ROCHESTER
FULTON COUNTY, INDIANA
LEAD SERVICE LINE
REPLACEMENT PROJECT - DAGO
AREA

© 2023 BY COMMONWEALTH ENGINEERS, INC. ALL RIGHTS RESERVED. REPRODUCTION BY ANY METHOD IN WHOLE OR IN PART WITHOUT PERMISSION IS PROHIBITED

Know what's below. 811 before you dig.
1-800-382-5544
(ITS THE LAW)

[illegible]

Designed By: AL	Drawn By: SSE	Checked By: RAL
Issue Date: SUBMITTAL	Project No: W24156	Scale: AS SHOWN

PLAN VIEW

W6-04

Sheet: 59 OF 86

FOR CONTINUATION SEE DWG W7-06



CONTRACTOR SHALL VERIFY THE EXISTING SERVICE LINE MATERIAL TO BE EITHER LEAD OR GALVANIZED PRIOR TO REPLACING THE SERVICE LINE. CONTRACTOR SHALL POTHOLE THE CITY-OWNED SIDE OF THE SERVICE LINE A MINIMUM OF 3 FT BACK FROM CURB STOP.

NEW 1" WATER SERVICE AND CURB STOP OR METER PIT

NEW 1-1/2" WATER SERVICE AND CURB STOP OR METER PIT

CURB STOP AND/OR METER PIT IS SHOWN FOR REPLACEMENT AND COULD NOT BE LOCATED IN THE FIELD. CONTRACTOR SHALL LOCATE PRIOR TO REPLACEMENT.


CONTRACTOR SHALL DISCONNECT EXISTING SERVICE LINE AT WATER MAIN AND ABANDON. EXISTING SERVICE LINE SHALL BE CUT AND CRIMPED. SERVICE LINE SHALL NOT BE REPLACED SINCE LOT IS EMPTY.

SCALE: 1"=20'-0"

FOR CONTINUATION SEE DWG W6-06



OFFICE LOCATIONS IN:
INDIANAPOLIS, IN. (2)
EVANSVILLE, IN.
FORT WAYNE, IN.
CROWN POINT, IN.
BOWLING GREEN, KY.
SOUTH BEND, IN.

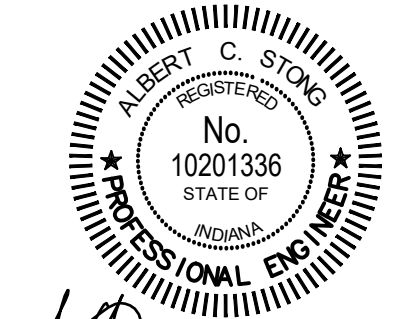

Signature 4/01/2025
Date

**CITY OF ROCHESTER
FULTON COUNTY, INDIANA
LEAD SERVICE LINE
REPLACEMENT PROJECT - DAC
AREA**

© 2023 BY COMMONWEALTH ENGINEERS, INC. ALL RIGHTS RESERVED. REPRODUCTION BY ANY METHOD IN WHOLE OR IN PART WITHOUT PERMISSION IS PROHIBITED

Indiana 811
Know what's below. 811 before you dig.
1-800-382-5544
(IT'S THE LAW)

[illegible]

Designed By: AL	Drawn By: SSE	Checked By: RAL
Issue Date: SUBMITTAL	Project No: W24156	Scale: AS SHOWN

PLAN VIEW

W6-05

Sheet: 60 OF 86

FOR CONTINUATION SEE DWG W7-07

SCALE: 1"=20'-0"




- ① CONTRACTOR SHALL VERIFY THE EXISTING SERVICE LINE MATERIAL TO BE EITHER LEAD OR GALVANIZED PRIOR TO REPLACING THE SERVICE LINE. CONTRACTOR SHALL POTHOLE THE CITY-OWNED SIDE OF THE SERVICE LINE A MINIMUM OF 3 FT BACK FROM CURB STOP.
- ② NEW 1" WATER SERVICE AND CURB STOP OR METER PIT
- ③ NEW 1-1/2" WATER SERVICE AND CURB STOP OR METER PIT
- ④ CURB STOP AND/OR METER PIT IS SHOWN FOR REPLACEMENT AND COULD NOT BE LOCATED IN THE FIELD. CONTRACTOR SHALL LOCATE PRIOR TO REPLACEMENT.
- ⑤ CONTRACTOR SHALL DISCONNECT EXISTING SERVICE LINE AT WATER MAIN AND ABANDON. EXISTING SERVICE LINE SHALL BE CUT AND CRIMPED. SERVICE LINE SHALL NOT BE REPLACED SINCE LOT IS EMPTY.



commonwealthengineers.com/

OFFICE LOCATIONS IN:

INDIANAPOLIS, IN. (2)
EVANSVILLE, IN.
FORT WAYNE, IN.
CROWN POINT, IN.
BOWLING GREEN, KY.
SOUTH BEND, IN.

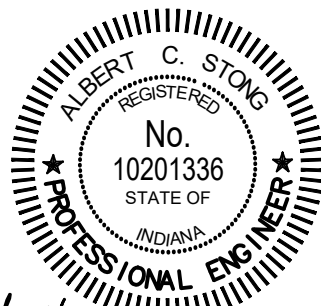

Signature	4/01/2025 Date
-----------	-------------------

**CITY OF ROCHESTER
FULTON COUNTY, INDIANA
LEAD SERVICE LINE
REPLACEMENT PROJECT - DAC
AREA**

© 2023 BY COMMONWEALTH ENGINEERS, INC. ALL RIGHTS RESERVED. REPRODUCTION BY ANY METHOD IN WHOLE OR IN PART WITHOUT PERMISSION IS PROHIBITED

[illegible]


Designed By: AL	Drawn By: SSE	Checked By: RAL
Issue Date: SUBMITTAL	Project No: W24156	Scale: AS SHOWN

PLAN VIEW

W6-06

Sheet: 61 OF 86

FOR CONTINUATION SEE DWG W6-06

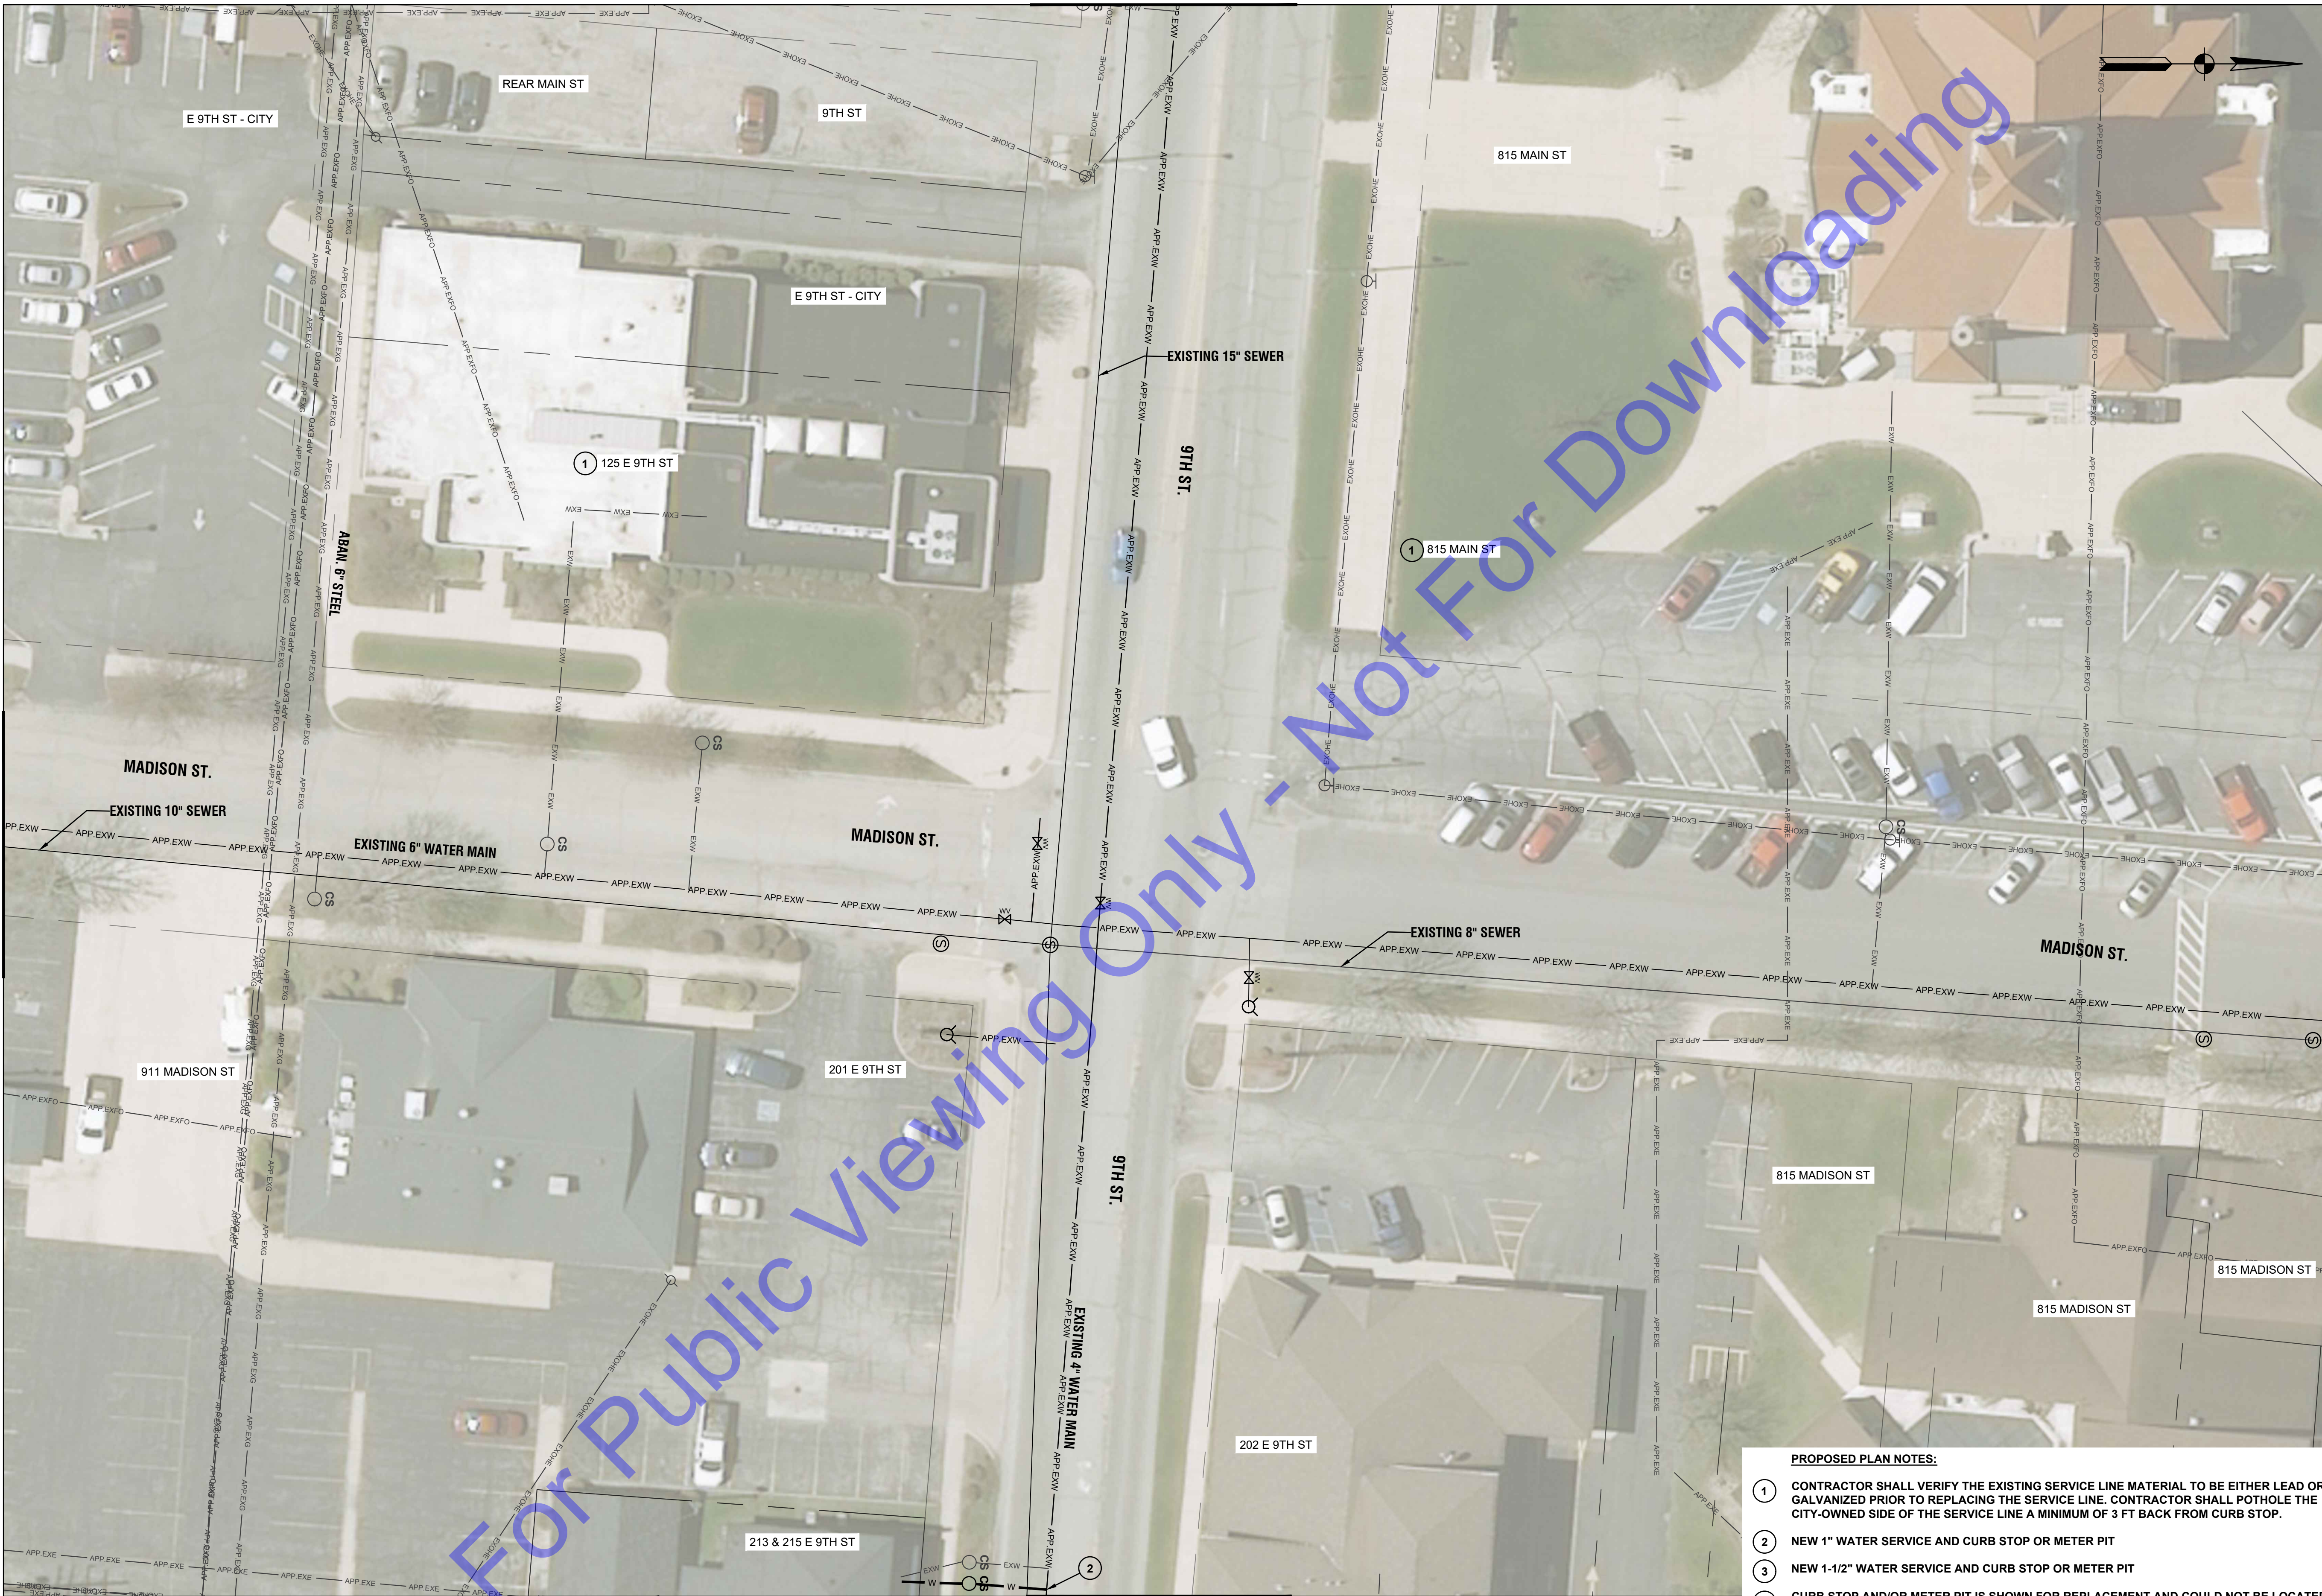

FOR CONTINUATION SEE DWG W7-08

PLAN VIEW

SCALE: 1"=20'-0"
0 20' 40'


PROPOSED PLAN NOTES:

- 1 CONTRACTOR SHALL VERIFY THE EXISTING SERVICE LINE MATERIAL TO BE EITHER LEAD OR GALVANIZED PRIOR TO REPLACING THE SERVICE LINE. CONTRACTOR SHALL POTHOLE THE CITY-OWNED SIDE OF THE SERVICE LINE A MINIMUM OF 3 FT BACK FROM CURB STOP.
- 2 NEW 1" WATER SERVICE AND CURB STOP OR METER PIT
- 3 NEW 1-1/2" WATER SERVICE AND CURB STOP OR METER PIT
- 4 CURB STOP AND/OR METER PIT IS SHOWN FOR REPLACEMENT AND COULD NOT BE LOCATED IN THE FIELD. CONTRACTOR SHALL LOCATE PRIOR TO REPLACEMENT.
- 5 CONTRACTOR SHALL DISCONNECT EXISTING SERVICE LINE AT WATER MAIN AND ABANDON. EXISTING SERVICE LINE SHALL BE CUT AND CRIMPED. SERVICE LINE SHALL NOT BE REPLACED SINCE LOT IS EMPTY.

FOR CONTINUATION SEE DWG W6-08



COMMONWEALTH
ENGINEERS, INC.
A Member of the Commonwealth Engineering Group

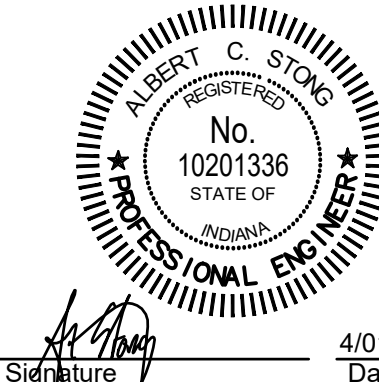

Signature: *Albert C. Stong* Date: 4/01/2025

CITY OF ROCHESTER
FULTON COUNTY, INDIANA
LEAD SERVICE LINE
REPLACEMENT PROJECT - DAC
AREA

© 2023 BY COMMONWEALTH
ENGINEERS, INC. ALL RIGHTS
RESERVED. REPRODUCTION
BY ANY METHOD IN WHOLE
OR IN PART WITHOUT THE
PERMISSION IS PROHIBITED



No.	Submittal / Revision	By	Date

Designed By: AL	Drawn By: SSE	Checked By: RAL
Issue Date: SUBMITTAL	Project No: W24156	Scale: AS SHOWN

PLAN VIEW

Drawing No:

W6-07

Sheet: 62 OF 86



FOR CONTINUATION SEE DWG W7-09

PLAN VIEW

SCALE: 1"=20'-0"

PROPOSED PLAN NOTES:

- 1 CONTRACTOR SHALL VERIFY THE EXISTING SERVICE LINE MATERIAL TO BE EITHER LEAD OR GALVANIZED PRIOR TO REPLACING THE SERVICE LINE. CONTRACTOR SHALL POTHOLE THE CITY-OWNED SIDE OF THE SERVICE LINE A MINIMUM OF 3 FT BACK FROM CURB STOP.
- 2 NEW 1" WATER SERVICE AND CURB STOP OR METER PIT
- 3 NEW 1-1/2" WATER SERVICE AND CURB STOP OR METER PIT
- 4 CURB STOP AND/OR METER PIT IS SHOWN FOR REPLACEMENT AND COULD NOT BE LOCATED IN THE FIELD. CONTRACTOR SHALL LOCATE PRIOR TO REPLACEMENT.
- 5 CONTRACTOR SHALL DISCONNECT EXISTING SERVICE LINE AT WATER MAIN AND ABANDON. EXISTING SERVICE LINE SHALL BE CUT AND CRIMPED. SERVICE LINE SHALL NOT BE REPLACED SINCE LOT IS EMPTY.

[illegible]

Designed By: AL	Drawn By: SSE	Checked By: RAL
Issue Date: SUBMITTAL	Project No: W24156	Scale: AS SHOWN

FOR CONTINUATION SEE DWG W6-08



PLAN VIEW

SCALE: 1"=20'-0"
0 20' 40'


PROPOSED PLAN NOTES:

- 1 CONTRACTOR SHALL VERIFY THE EXISTING SERVICE LINE MATERIAL TO BE EITHER LEAD OR GALVANIZED PRIOR TO REPLACING THE SERVICE LINE. CONTRACTOR SHALL POTHOLE THE CITY-OWNED SIDE OF THE SERVICE LINE A MINIMUM OF 3 FT BACK FROM CURB STOP.
- 2 NEW 1" WATER SERVICE AND CURB STOP OR METER PIT
- 3 NEW 1-1/2" WATER SERVICE AND CURB STOP OR METER PIT
- 4 CURB STOP AND/OR METER PIT IS SHOWN FOR REPLACEMENT AND COULD NOT BE LOCATED IN THE FIELD. CONTRACTOR SHALL LOCATE PRIOR TO REPLACEMENT.
- 5 CONTRACTOR SHALL DISCONNECT EXISTING SERVICE LINE AT WATER MAIN AND ABANDON. EXISTING SERVICE LINE SHALL BE CUT AND CRIMPED. SERVICE LINE SHALL NOT BE REPLACED SINCE LOT IS EMPTY.

FOR CONTINUATION SEE DWG W6-10



COMMONWEALTH
ENGINEERS, INC.
A member of the Commonwealth Engineering Group
OFFICE LOCATIONS IN:
INDIANAPOLIS, IN (2)
EVANSVILLE, IN
FORT WAYNE, IN
CROWN POINT, IN
BOWLING GREEN, KY
SOUTH BEND, IN
<https://commonwealthengineers.com/>

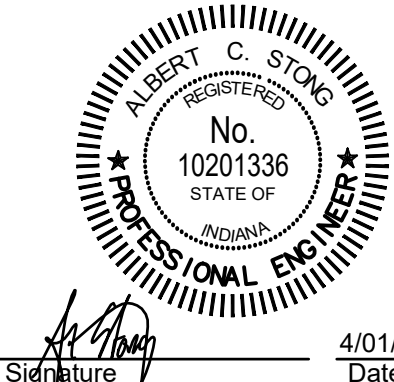

Signature: *Albert C. Stong* Date: 4/01/2025

CITY OF ROCHESTER
FULTON COUNTY, INDIANA
LEAD SERVICE LINE
REPLACEMENT PROJECT - DAC
AREA

© 2023 BY COMMONWEALTH ENGINEERS, INC. ALL RIGHTS RESERVED. REPRODUCTION BY ANY METHOD IN WHOLE OR IN PART WITHOUT PERMISSION IS PROHIBITED.
Indiana 811
Know what's below. 811 before you dig.
1-800-382-5544
(IT'S THE LAW)

No.	Submittal / Revision	By	Date

Designed By: AL	Drawn By: SSE	Checked By: RAL
Issue Date: SUBMITTAL	Project No: W24156	Scale: AS SHOWN

PLAN VIEW

Drawing No:

W6-09

Sheet: 64 OF 86

FOR CONTINUATION SEE DWG W6-08


FOR CONTINUATION SEE DWG W5-10



FOR CONTINUATION SEE DWG W6-11

PLAN VIEW

SCALE: 1"=20'-0"

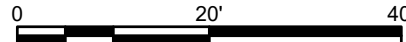

PROPOSED PLAN NOTES:

- ① CONTRACTOR SHALL VERIFY THE EXISTING SERVICE LINE MATERIAL TO BE EITHER LEAD OR GALVANIZED PRIOR TO REPLACING THE SERVICE LINE. CONTRACTOR SHALL POTHOLE THE CITY-OWNED SIDE OF THE SERVICE LINE A MINIMUM OF 3 FT BACK FROM CURB STOP.
- ② NEW 1" WATER SERVICE AND CURB STOP OR METER PIT
- ③ NEW 1-1/2" WATER SERVICE AND CURB STOP OR METER PIT
- ④ CURB STOP AND/OR METER PIT IS SHOWN FOR REPLACEMENT AND COULD NOT BE LOCATED IN THE FIELD. CONTRACTOR SHALL LOCATE PRIOR TO REPLACEMENT.
- ⑤ CONTRACTOR SHALL DISCONNECT EXISTING SERVICE LINE AT WATER MAIN AND ABANDON. EXISTING SERVICE LINE SHALL BE CUT AND CRIMPED. SERVICE LINE SHALL NOT BE REPLACED SINCE LOT IS EMPTY.

COMMONWEALTHTM
ENGINEERS, INC.
A wealth of resources to master a common goal.

<https://commonwealthengineers.com/>

OFFICE LOCATIONS IN:
INDIANAPOLIS, IN. (2)
EVANSVILLE, IN.
FORT WAYNE, IN.
CROWN POINT, IN.
BOWLING GREEN, KY.
SOUTH BEND, IN.



Signature

4/01/2025
Date

**CITY OF ROCHESTER
FULTON COUNTY, INDIANA
LEAD SERVICE LINE
REPLACEMENT PROJECT - DAC
AREA**

© 2023 BY COMMONWEALTH ENGINEERS, INC. ALL RIGHTS RESERVED. REPRODUCTION BY ANY METHOD IN WHOLE OR IN PART WITHOUT PERMISSION IS PROHIBITED



Know what's below. 811 before you dig.
1-800-382-5544
(ITS THE LAW)

[illegible]

Designed By: AL	Drawn By: SSE	Checked By: RAL
Issue Date: SUBMITTAL	Project No: W24156	Scale: AS SHOWN

PLAN VIEW

Drawing No:

W6-10


Sheet: 65 OF 86

FOR CONTINUATION SEE DWG W5-12



PLAN VIEW

SCALE: 1"=20'-0"

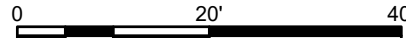


PROPOSED PLAN NOTES:

- ① CONTRACTOR SHALL VERIFY THE EXISTING SERVICE LINE MATERIAL TO BE EITHER LEAD OR GALVANIZED PRIOR TO REPLACING THE SERVICE LINE. CONTRACTOR SHALL POTHOLE THE CITY-OWNED SIDE OF THE SERVICE LINE A MINIMUM OF 3 FT BACK FROM CURB STOP.
- ② NEW 1" WATER SERVICE AND CURB STOP OR METER PIT
- ③ NEW 1-1/2" WATER SERVICE AND CURB STOP OR METER PIT
- ④ CURB STOP AND/OR METER PIT IS SHOWN FOR REPLACEMENT AND COULD NOT BE LOCATED IN THE FIELD. CONTRACTOR SHALL LOCATE PRIOR TO REPLACEMENT.
- ⑤ CONTRACTOR SHALL DISCONNECT EXISTING SERVICE LINE AT WATER MAIN AND ABANDON. EXISTING SERVICE LINE SHALL BE CUT AND CRIMPED. SERVICE LINE SHALL NOT BE REPLACED SINCE LOT IS EMPTY.



<https://commonwealthengineers.com/>

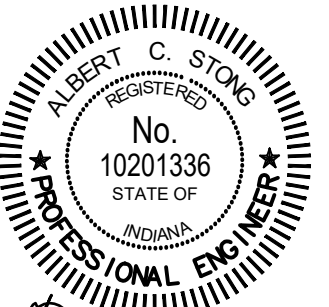

Signature

4/01/2025
Date

**CITY OF ROCHESTER
FULTON COUNTY, INDIANA
LEAD SERVICE LINE
REPLACEMENT PROJECT - DAC
AREA**

© 2023 BY COMMONWEALTH ENGINEERS, INC. ALL RIGHTS RESERVED. REPRODUCTION BY ANY METHOD IN WHOLE OR IN PART WITHOUT PERMISSION IS PROHIBITED



Know what's below. 811 before you dig.
1-800-382-5544
(ITS THE LAW)

[illegible]

Designed By: AL	Drawn By: SSE	Checked By: RAL
--------------------	------------------	--------------------

Issue Date:	Project No:	Scale:
SUBMITTAL	W24156	AS SHOWN

PLAN VIEW

Drawing No:

W6-11

Sheet: 66 OF 86




PROPOSED PLAN NOTES:

- ① CONTRACTOR SHALL VERIFY THE EXISTING SERVICE LINE MATERIAL TO BE EITHER LEAD OR GALVANIZED PRIOR TO REPLACING THE SERVICE LINE. CONTRACTOR SHALL POTHOLE THE CITY-OWNED SIDE OF THE SERVICE LINE A MINIMUM OF 3 FT BACK FROM CURB STOP.
- ② NEW 1" WATER SERVICE AND CURB STOP OR METER PIT
- ③ NEW 1-1/2" WATER SERVICE AND CURB STOP OR METER PIT
- ④ CURB STOP AND/OR METER PIT IS SHOWN FOR REPLACEMENT AND COULD NOT BE LOCATED IN THE FIELD. CONTRACTOR SHALL LOCATE PRIOR TO REPLACEMENT.
- ⑤ CONTRACTOR SHALL DISCONNECT EXISTING SERVICE LINE AT WATER MAIN AND ABANDON. EXISTING SERVICE LINE SHALL BE CUT AND CRIMPED. SERVICE LINE SHALL NOT BE REPLACED SINCE LOT IS EMPTY.

FOR CONTINUATION SEE DWG W8-01

PLAN VIEW

SCALE: 1"=20'-0"

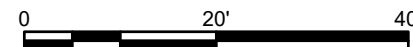

FOR CONTINUATION SEE DWG W7-02

CITY OF ROCHESTER
FULTON COUNTY, INDIANA
LEAD SERVICE LINE
REPLACEMENT PROJECT - DAC
AREA

© 2023 BY COMMONWEALTH ENGINEERS, INC. ALL RIGHTS RESERVED. REPRODUCTION BY ANY METHOD IN WHOLE OR IN PART WITHOUT PERMISSION IS PROHIBITED



Know what's below. 811 before you dig.
1-800-382-5544
(ITS THE LAW)

[illegible]

Designed By: AL	Drawn By: SSE	Checked By: RAL
Issue Date: SUBMITTAL	Project No: W24156	Scale: AS SHOWN

PLAN VIEW

Drawing No:

W7-01

Sheet: 67 OF 86

FOR CONTINUATION SEE DWG W7-01




FOR CONTINUATION SEE DWG W8-03

PLAN VIEW

SCALE: 1"=20'-0"
0 20' 40'

PROPOSED PLAN NOTES:

- 1 CONTRACTOR SHALL VERIFY THE EXISTING SERVICE LINE MATERIAL TO BE EITHER LEAD OR GALVANIZED PRIOR TO REPLACING THE SERVICE LINE. CONTRACTOR SHALL POT-HOLE THE CITY-OWNED SIDE OF THE SERVICE LINE A MINIMUM OF 3 FT BACK FROM CURB STOP.
- 2 NEW 1" WATER SERVICE AND CURB STOP OR METER PIT
- 3 NEW 1-1/2" WATER SERVICE AND CURB STOP OR METER PIT
- 4 CURB STOP AND/OR METER PIT IS SHOWN FOR REPLACEMENT AND COULD NOT BE LOCATED IN THE FIELD. CONTRACTOR SHALL LOCATE PRIOR TO REPLACEMENT.
- 5 CONTRACTOR SHALL DISCONNECT EXISTING SERVICE LINE AT WATER MAIN AND ABANDON. EXISTING SERVICE LINE SHALL BE CUT AND CRIMPED. SERVICE LINE SHALL NOT BE REPLACED SINCE LOT IS EMPTY.

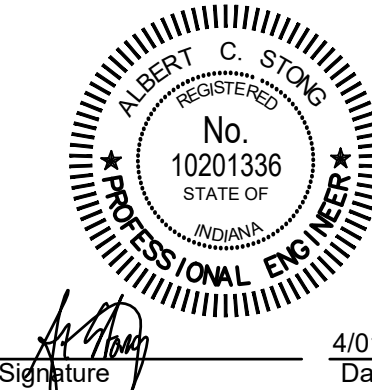

CITY OF ROCHESTER
FULTON COUNTY, INDIANA
LEAD SERVICE LINE
REPLACEMENT PROJECT - DAC
AREA

© 2023 BY COMMONWEALTH ENGINEERS, INC. ALL RIGHTS RESERVED. REPRODUCTION BY ANY METHOD IN WHOLE OR IN PART WITHOUT PERMISSION IS PROHIBITED.
Indiana 811
Know what's below. 811 before you dig.
1-800-382-5544
(IT'S THE LAW)

No.	Submital / Revision	By	Date

Designed By: AL	Drawn By: SSE	Checked By: RAL
Issue Date: SUBMITTAL	Project No: W24156	Scale: AS SHOWN

PLAN VIEW

Drawing No:
W7-02
Sheet: 68 OF 86

FOR CONTINUATION SEE DWG W7-02

FOR CONTINUATION SEE DWG W6-02



FOR CONTINUATION SEE DWG W7-04

**CITY OF ROCHESTER
FULTON COUNTY, INDIANA
LEAD SERVICE LINE
REPLACEMENT PROJECT - DAC
AREA**

ENGINEERS, INC. ALL RIGHTS
RESERVED. REPRODUCTION
BY ANY METHOD IN WHOLE
OR IN PART WITHOUT
PERMISSION IS PROHIBITED

Indiana 811

Know what's below. 811 before you dig.
1-800-382-5544
(ITS THE LAW)

[illegible]


Designed By: AL	Drawn By: SSE	Checked By: RAL
Issue Date: SUBMITTAL	Project No: W24156	Scale: AS SHOWN

PLAN VIEW

Drawing No:

W7-03


Sheet: 69 OF 86

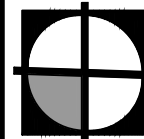

COMMONWEALTHTM
ENGINEERS, INC.
A wealth of resources to master a common goal.

<https://commonwealthengineers.com/>

OFFICE LOCATIONS IN:
INDIANAPOLIS, IN. (2)
EVANSVILLE, IN.
FORT WAYNE, IN.
CROWN POINT, IN.
BOWLING GREEN, KY.
SOUTH BEND, IN.

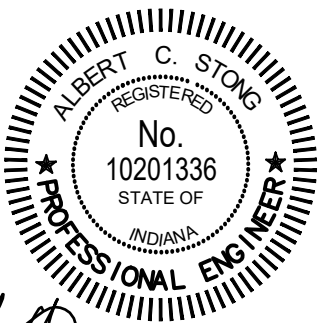

Signature

4/01/2025
Date

FOR CONTINUATION SEE DWG W7-03

FOR CONTINUATION SEE DWG W6-03

FOR CONTINUATION SEE DWG W7-05

PROPOSED PLAN NOTES:

- 1 CONTRACTOR SHALL VERIFY THE EXISTING SERVICE LINE MATERIAL TO BE EITHER LEAD OR GALVANIZED PRIOR TO REPLACING THE SERVICE LINE. CONTRACTOR SHALL POTHOLE THE CITY-OWNED SIDE OF THE SERVICE LINE A MINIMUM OF 3 FT BACK FROM CURB STOP.
- 2 NEW 1" WATER SERVICE AND CURB STOP OR METER PIT
- 3 NEW 1-1/2" WATER SERVICE AND CURB STOP OR METER PIT
- 4 CURB STOP AND/OR METER PIT IS SHOWN FOR REPLACEMENT AND COULD NOT BE LOCATED IN THE FIELD. CONTRACTOR SHALL LOCATE PRIOR TO REPLACEMENT.
- 5 CONTRACTOR SHALL DISCONNECT EXISTING SERVICE LINE AT WATER MAIN AND ABANDON. EXISTING SERVICE LINE SHALL BE CUT AND CRIMPED. SERVICE LINE SHALL NOT BE REPLACED SINCE LOT IS EMPTY.

FOR CONTINUATION SEE DWG W8-04


PLAN VIEW

SCALE: 1"=20'-0"

0 20' 40'



COMMONWEALTH
ENGINEERS, INC.
A PROFESSIONAL CORPORATION
OFFICE LOCATIONS IN:
INDIANAPOLIS, IN (2)
EVANSVILLE, IN
FORT WAYNE, IN
CROWNING POINT, IN
SOUTH BEND, IN
<https://commonwealthengineers.com/>

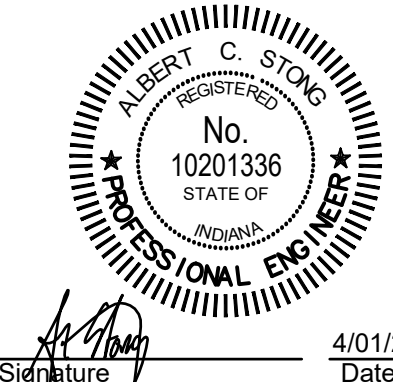

Signature: *Albert C. Stong* Date: 4/01/2025

CITY OF ROCHESTER
FULTON COUNTY, INDIANA
LEAD SERVICE LINE
REPLACEMENT PROJECT - DAC
AREA

© 2023 BY COMMONWEALTH ENGINEERS, INC. ALL RIGHTS RESERVED. REPRODUCTION BY ANY METHOD IN WHOLE OR IN PART WITHOUT PERMISSION IS PROHIBITED.
Indiana 811
Know what's below. 811 before you dig.
1-800-382-5544
(IT'S THE LAW)

No.	Submittal / Revision	By	Date

Designed By: AL	Drawn By: SSE	Checked By: RAL
Issue Date: SUBMITTAL	Project No: W24156	Scale: AS SHOWN

PLAN VIEW

Drawing No:

W7-04

Sheet: 70 OF 86



SCALE: 1"=20'-0"

- ① CONTRACTOR SHALL VERIFY THE EXISTING SERVICE LINE MATERIAL TO BE EITHER LEAD OR GALVANIZED PRIOR TO REPLACING THE SERVICE LINE. CONTRACTOR SHALL POTHOLE THE CITY-OWNED SIDE OF THE SERVICE LINE A MINIMUM OF 3 FT BACK FROM CURB STOP.
- ② NEW 1" WATER SERVICE AND CURB STOP OR METER PIT
- ③ NEW 1-1/2" WATER SERVICE AND CURB STOP OR METER PIT
- ④ CURB STOP AND/OR METER PIT IS SHOWN FOR REPLACEMENT AND COULD NOT BE LOCATED IN THE FIELD. CONTRACTOR SHALL LOCATE PRIOR TO REPLACEMENT.
- ⑤ CONTRACTOR SHALL DISCONNECT EXISTING SERVICE LINE AT WATER MAIN AND ABANDON. EXISTING SERVICE LINE SHALL BE CUT AND CRIMPED. SERVICE LINE SHALL NOT BE REPLACED SINCE LOT IS EMPTY.




COMMONWEALTHTM
ENGINEERS, INC.

A wealth of resources to make a common road.

commonwealthengineers.com/

OFFICE LOCATIONS IN:
INDIANAPOLIS, IN. (2)
EVANSVILLE, IN.
FORT WAYNE, IN.
CROWN POINT, IN.
BOWLING GREEN, KY.
SOUTH BEND, IN.



Albert C. Stong
REGISTERED
No.
10201336
STATE OF
INDIANA
PROFESSIONAL ENGINEER

Signature: *Albert C. Stong*

4/01/2011

**CITY OF ROCHESTER
FULTON COUNTY, INDIANA
LEAD SERVICE LINE
REPLACEMENT PROJECT - DAC
AREA**

© 2023 BY COMMONWEALTH ENGINEERS, INC. ALL RIGHTS RESERVED. REPRODUCTION BY ANY METHOD IN WHOLE OR IN PART WITHOUT PERMISSION IS PROHIBITED

Indiana81

Know what's below. 811 before you dig.
1-800-382-5544
(ITS THE LAW)

[illegible]

Designed By: AL	Drawn By: SSE	Checked By: RAL
Issue Date: SUBMITTAL	Project No: W24156	Scale: AS SHOWN

PLAN VIEW

Drawing No:

W7-05

Sheet: 71 OF 86

FOR CONTINUATION SEE DWG W7-07



SCALE: 1"=20'-0"

SCALE: 1"=20'-0"

- PROPOSED PLAN NOTES:**


[illegible]

PLAN VIEW

Drawing No:

W7-06

Sheet: 72 OF 86

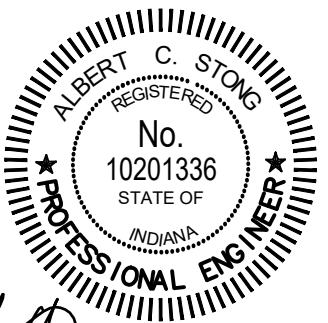

Signature 4/01/2025
Date

**CITY OF ROCHESTER
FULTON COUNTY, INDIANA
LEAD SERVICE LINE
REPLACEMENT PROJECT - DAC
AREA**

© 2023 BY COMMONWEALTH ENGINEERS, INC. ALL RIGHTS RESERVED. REPRODUCTION BY ANY METHOD IN WHOLE OR IN PART WITHOUT PERMISSION IS PROHIBITED



PROPOSED PLAN NOTES:

- ① CONTRACTOR SHALL VERIFY THE EXISTING SERVICE LINE MATERIAL TO BE EITHER LEAD OR GALVANIZED PRIOR TO REPLACING THE SERVICE LINE. CONTRACTOR SHALL POTHOLE THE CITY-OWNED SIDE OF THE SERVICE LINE A MINIMUM OF 3 FT BACK FROM CURB STOP.
- ② NEW 1" WATER SERVICE AND CURB STOP OR METER PIT
- ③ NEW 1-1/2" WATER SERVICE AND CURB STOP OR METER PIT
- ④ CURB STOP AND/OR METER PIT IS SHOWN FOR REPLACEMENT AND COULD NOT BE LOCATED IN THE FIELD. CONTRACTOR SHALL LOCATE PRIOR TO REPLACEMENT.
- ⑤ CONTRACTOR SHALL DISCONNECT EXISTING SERVICE LINE AT WATER MAIN AND ABANDON. EXISTING SERVICE LINE SHALL BE CUT AND CRIMPED. SERVICE LINE SHALL NOT BE REPLACED SINCE LOT IS EMPTY.

FOR CONTINUATION SEE DWG W7-07

FOR CONTINUATION SEE DWG W6-07



FOR CONTINUATION SEE DWG W8-08

PLAN VIEW

SCALE: 1"=20'-0"


0 20' 40'

A horizontal scale bar with alternating black and white segments. It is marked with '0' at the left end, '20'' at the midpoint, and '40'' at the right end.

FOR CONTINUATION SEE DWG W7-09



COMMONWEALTHTM
ENGINEERS, INC.
A wealth of resources to master a common goal.

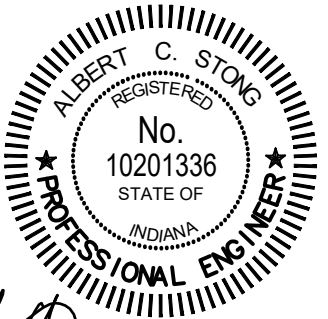

Signature 4/01/2025
Date

**CITY OF ROCHESTER
FULTON COUNTY, INDIANA
LEAD SERVICE LINE
REPLACEMENT PROJECT - DAC
AREA**

© 2023 BY COMMONWEALTH ENGINEERS, INC. ALL RIGHTS RESERVED. REPRODUCTION BY ANY METHOD IN WHOLE OR IN PART WITHOUT PERMISSION IS PROHIBITED

Indiana811

Know what's below. 811 before you dig.
1-800-382-5544
(ITS THE LAW)

[illegible]

Designed By: AL	Drawn By: SSE	Checked By: RAL
Issue Date: SUBMITTAL	Project No: W24156	Scale: AS SHOWN

PLAN VIEW

Drawing No:

W7-08

Sheet: 74 OF 86

FOR CONTINUATION SEE DWG W7-08



PLAN VIEW

SCALE: 1"=20'-0"
0 20' 40'


PROPOSED PLAN NOTES:

- 1 CONTRACTOR SHALL VERIFY THE EXISTING SERVICE LINE MATERIAL TO BE EITHER LEAD OR GALVANIZED PRIOR TO REPLACING THE SERVICE LINE. CONTRACTOR SHALL POTHOLE THE CITY-OWNED SIDE OF THE SERVICE LINE A MINIMUM OF 3 FT BACK FROM CURB STOP.
- 2 NEW 1" WATER SERVICE AND CURB STOP OR METER PIT
- 3 NEW 1-1/2" WATER SERVICE AND CURB STOP OR METER PIT
- 4 CURB STOP AND/OR METER PIT IS SHOWN FOR REPLACEMENT AND COULD NOT BE LOCATED IN THE FIELD. CONTRACTOR SHALL LOCATE PRIOR TO REPLACEMENT.
- 5 CONTRACTOR SHALL DISCONNECT EXISTING SERVICE LINE AT WATER MAIN AND ABANDON. EXISTING SERVICE LINE SHALL BE CUT AND CRIMPED. SERVICE LINE SHALL NOT BE REPLACED SINCE LOT IS EMPTY.



OFFICE LOCATIONS IN:
INDIANAPOLIS, IN (2)
EVANSVILLE, IN
FORT WAYNE, IN
CROWNING POINT, IN
BOWLING GREEN, KY
SOUTH BEND, IN

<https://commonwealthengineers.com/>

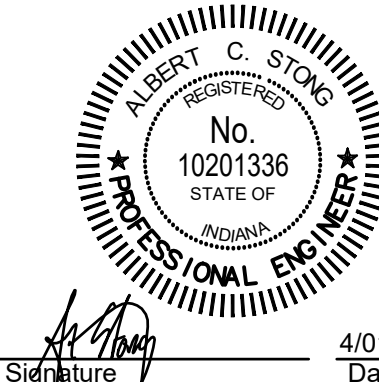

Signature: *Albert C. Stong* Date: 4/01/2025

CITY OF ROCHESTER
FULTON COUNTY, INDIANA
LEAD SERVICE LINE
REPLACEMENT PROJECT - DAC
AREA

© 2023 BY COMMONWEALTH ENGINEERS, INC. ALL RIGHTS RESERVED. REPRODUCTION BY ANY METHOD IN WHOLE OR IN PART WITHOUT PERMISSION IS PROHIBITED



Know what's below. 811 before you dig.
1-800-382-5544
(IT'S THE LAW)

No.	Submital / Revision	By	Date

Designed By: AL	Drawn By: SSE	Checked By: RAL
Issue Date: SUBMITTAL	Project No: W24156	Scale: AS SHOWN

PLAN VIEW

Drawing No:

W7-09

Sheet: 75 OF 86


FOR CONTINUATION SEE DWG W7-01



FOR CONTINUATION SEE DWG W8-02

PLAN VIEW

SCALE: 1"=20'-0"

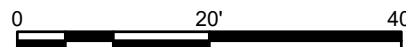


PROPOSED PLAN NOTES:

- ① CONTRACTOR SHALL VERIFY THE EXISTING SERVICE LINE MATERIAL TO BE EITHER LEAD OR GALVANIZED PRIOR TO REPLACING THE SERVICE LINE. CONTRACTOR SHALL POTHOLE THE CITY-OWNED SIDE OF THE SERVICE LINE A MINIMUM OF 3 FT BACK FROM CURB STOP.
- ② NEW 1" WATER SERVICE AND CURB STOP OR METER PIT
- ③ NEW 1-1/2" WATER SERVICE AND CURB STOP OR METER PIT
- ④ CURB STOP AND/OR METER PIT IS SHOWN FOR REPLACEMENT AND COULD NOT BE LOCATED IN THE FIELD. CONTRACTOR SHALL LOCATE PRIOR TO REPLACEMENT.
- ⑤ CONTRACTOR SHALL DISCONNECT EXISTING SERVICE LINE AT WATER MAIN AND ABANDON. EXISTING SERVICE LINE SHALL BE CUT AND CRIMPED. SERVICE LINE SHALL NOT BE REPLACED SINCE LOT IS EMPTY.



COMMONWEALTHTM
ENGINEERS, INC.

A wealth of resources to master a common goal.



Signature: *Albert C. Stong*

4/01/2014

Date: _____

**CITY OF ROCHESTER
FULTON COUNTY, INDIANA
LEAD SERVICE LINE
REPLACEMENT PROJECT - DAC
AREA**

© 2023 BY COMMONWEALTH ENGINEERS, INC. ALL RIGHTS RESERVED. REPRODUCTION BY ANY METHOD IN WHOLE OR IN PART WITHOUT PERMISSION IS PROHIBITED



Know what's below. 811 before you dig.
1-800-382-5544
(ITS THE LAW)

[illegible]

Designed By: AL	Drawn By: SSE	Checked By: RAL
Issue Date: SUBMITTAL	Project No: W24156	Scale: AS SHOWN

PLAN VIEW

Drawing No:


W8-01

Sheet: 76 OF 86



PLAN VIEW

SCALE: 1"=20'-0"

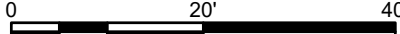


PROPOSED PLAN NOTES:

- ① CONTRACTOR SHALL VERIFY THE EXISTING SERVICE LINE MATERIAL TO BE EITHER LEAD OR GALVANIZED PRIOR TO REPLACING THE SERVICE LINE. CONTRACTOR SHALL POTHOLE THE CITY-OWNED SIDE OF THE SERVICE LINE A MINIMUM OF 3 FT BACK FROM CURB STOP.
- ② NEW 1" WATER SERVICE AND CURB STOP OR METER PIT
- ③ NEW 1-1/2" WATER SERVICE AND CURB STOP OR METER PIT
- ④ CURB STOP AND/OR METER PIT IS SHOWN FOR REPLACEMENT AND COULD NOT BE LOCATED IN THE FIELD. CONTRACTOR SHALL LOCATE PRIOR TO REPLACEMENT.
- ⑤ CONTRACTOR SHALL DISCONNECT EXISTING SERVICE LINE AT WATER MAIN AND ABANDON. EXISTING SERVICE LINE SHALL BE CUT AND CRIMPED. SERVICE LINE SHALL NOT BE REPLACED SINCE LOT IS EMPTY.



COMMONWEALTHTM
ENGINEERS, INC.
A wealth of resources to master a common goal.

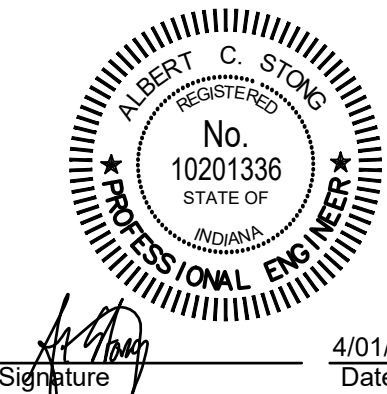

**CITY OF ROCHESTER
FULTON COUNTY, INDIANA
LEAD SERVICE LINE
REPLACEMENT PROJECT - DAC
AREA**

© 2023 BY COMMONWEALTH ENGINEERS, INC. ALL RIGHTS RESERVED. REPRODUCTION BY ANY METHOD IN WHOLE OR IN PART WITHOUT PERMISSION IS PROHIBITED



1-800-382-5544
(ITS THE LAW)

[illegible]

Designed By: AL	Drawn By: SSE	Checked By: RAL
Issue Date: SUBMITTAL	Project No: W24156	Scale: AS SHOWN


PLAN VIEW

Drawing No:


W8-02

Sheet: 77 OF 86

FOR CONTINUATION SEE DWG W8-02

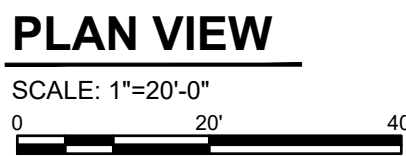

- ① CONTRACTOR SHALL VERIFY THE EXISTING SERVICE LINE MATERIAL TO BE EITHER LEAD OR GALVANIZED PRIOR TO REPLACING THE SERVICE LINE. CONTRACTOR SHALL POTHOLE THE CITY-OWNED SIDE OF THE SERVICE LINE A MINIMUM OF 3 FT BACK FROM CURB STOP.
- ② NEW 1" WATER SERVICE AND CURB STOP OR METER PIT
- ③ NEW 1-1/2" WATER SERVICE AND CURB STOP OR METER PIT
- ④ CURB STOP AND/OR METER PIT IS SHOWN FOR REPLACEMENT AND COULD NOT BE LOCATED IN THE FIELD. CONTRACTOR SHALL LOCATE PRIOR TO REPLACEMENT.
- ⑤ CONTRACTOR SHALL DISCONNECT EXISTING SERVICE LINE AT WATER MAIN AND ABANDON. EXISTING SERVICE LINE SHALL BE CUT AND CRIMPED. SERVICE LINE SHALL NOT BE REPLACED SINCE LOT IS EMPTY.



Signature _____ Date 4/01/2014

© 2023 BY COMMONWEALTH
ENGINEERS, INC. ALL RIGHTS
RESERVED. REPRODUCTION
BY ANY METHOD IN WHOLE
OR IN PART WITHOUT
PERMISSION IS PROHIBITED

Indiana 811

Know what's below. 811 before you dig.

1-800-382-5544
(IT'S THE LAW)

Designed By: AL	Drawn By: SSE	Checked By: RAL
Issue Date: SUBMITTAL	Project No: W24156	Scale: AS SHOWN

Drawing No:

W8-03

FOR CONTINUATION SEE DWG W8-03

FOR CONTINUATION SEE DWG W7-04



FOR CONTINUATION SEE DWG W8-05

**CITY OF ROCHESTER
FULTON COUNTY, INDIANA
LEAD SERVICE LINE
REPLACEMENT PROJECT - DAC
AREA**

© 2023 BY COMMONWEALTH ENGINEERS, INC. ALL RIGHTS RESERVED. REPRODUCTION BY ANY METHOD IN WHOLE OR IN PART WITHOUT PERMISSION IS PROHIBITED

Indiana 811
Know what's below. 811 before you dig.
1-800-382-5544
(IT'S THE LAW)

[illegible]

Designed By: AL	Drawn By: SSE	Checked By: RAL
Issue Date: SUBMITTAL	Project No: W24156	Scale: AS SHOWN

PLAN VIEW

Drawing No:


W8-04

Sheet: 79 OF 86



<https://commonwealthengineers.com/>

OFFICE LOCATIONS IN:
INDIANAPOLIS, IN. (2)
EVANSVILLE, IN.
FORT WAYNE, IN.
CROWN POINT, IN.
BOWLING GREEN, KY.
SOUTH BEND, IN.

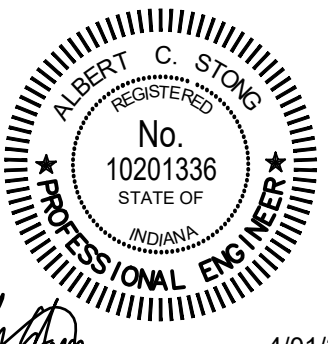


Signature _____ Date 4/01/2025

FOR CONTINUATION SEE DWG W7-05



PLAN VIEW

SCALE: 1"=20'-0"

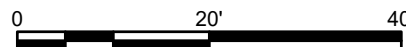


PROPOSED PLAN NOTES:

- ① CONTRACTOR SHALL VERIFY THE EXISTING SERVICE LINE MATERIAL TO BE EITHER LEAD OR GALVANIZED PRIOR TO REPLACING THE SERVICE LINE. CONTRACTOR SHALL POTHOLE THE CITY-OWNED SIDE OF THE SERVICE LINE A MINIMUM OF 3 FT BACK FROM CURB STOP.
- ② NEW 1" WATER SERVICE AND CURB STOP OR METER PIT
- ③ NEW 1-1/2" WATER SERVICE AND CURB STOP OR METER PIT
- ④ CURB STOP AND/OR METER PIT IS SHOWN FOR REPLACEMENT AND COULD NOT BE LOCATED IN THE FIELD. CONTRACTOR SHALL LOCATE PRIOR TO REPLACEMENT.
- ⑤ CONTRACTOR SHALL DISCONNECT EXISTING SERVICE LINE AT WATER MAIN AND ABANDON. EXISTING SERVICE LINE SHALL BE CUT AND CRIMPED. SERVICE LINE SHALL NOT BE REPLACED SINCE LOT IS EMPTY.



COMMONWEALTHTM
ENGINEERS, INC.
A wealth of resources to meet a common goal.



Signature _____ Date 4/01/2014

**CITY OF ROCHESTER
FULTON COUNTY, INDIANA
LEAD SERVICE LINE
REPLACEMENT PROJECT - DAC
AREA**

© 2023 BY COMMONWEALTH
ENGINEERS, INC. ALL RIGHTS
RESERVED. REPRODUCTION
BY ANY METHOD IN WHOLE
OR IN PART WITHOUT
PERMISSION IS PROHIBITED

Indiana811

[illegible]

Designed By: AL	Drawn By: SSE	Checked By: RAL
Issue Date: SUBMITTAL	Project No: W24156	Scale: AS SHOWN

PLAN VIEW

Drawing No:

W8-05


Sheet: 80 OF 86

FOR CONTINUATION SEE DWG W7-06



PLAN VIEW

SCALE: 1"=20'-0"

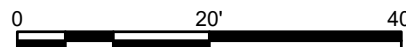

PROPOSED PLAN NOTES:


- 1 CONTRACTOR SHALL VERIFY THE EXISTING SERVICE LINE MATERIAL TO BE EITHER LEAD OR GALVANIZED PRIOR TO REPLACING THE SERVICE LINE. CONTRACTOR SHALL POTHOLE THE CITY-OWNED SIDE OF THE SERVICE LINE A MINIMUM OF 3 FT BACK FROM CURB STOP.
- 2 NEW 1" WATER SERVICE AND CURB STOP OR METER PIT
- 3 NEW 1-1/2" WATER SERVICE AND CURB STOP OR METER PIT
- 4 CURB STOP AND/OR METER PIT IS SHOWN FOR REPLACEMENT AND COULD NOT BE LOCATED IN THE FIELD. CONTRACTOR SHALL LOCATE PRIOR TO REPLACEMENT.
- 5 CONTRACTOR SHALL DISCONNECT EXISTING SERVICE LINE AT WATER MAIN AND ABANDON. EXISTING SERVICE LINE SHALL BE CUT AND CRIMPED. SERVICE LINE SHALL NOT BE REPLACED SINCE LOT IS EMPTY.

FOR CONTINUATION SEE DWG W8-07



COMMONWEALTHTM
ENGINEERS, INC.
A wealth of resources to master a common goal.

<https://commonwealthengineers.com/>

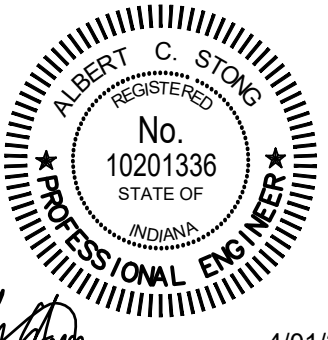

Signature

4/01/2025
Date

**CITY OF ROCHESTER
FULTON COUNTY, INDIANA
LEAD SERVICE LINE
REPLACEMENT PROJECT - DAC
AREA**

© 2023 BY COMMONWEALTH ENGINEERS, INC. ALL RIGHTS RESERVED. REPRODUCTION BY ANY METHOD IN WHOLE OR IN PART WITHOUT PERMISSION IS PROHIBITED

Indiana811

Know what's below. 811 before you dig.
1-800-382-5544
(IT'S THE I AW)

[illegible]

Designed By: AL	Drawn By: SSE	Checked By: RAL
Issue Date: SUBMITTAL	Project No: W24156	Scale: AS SHOWN

PLAN VIEW

Drawing No:

W8-06

Sheet: 81 OF 86

FOR CONTINUATION SEE DWG W8-06

FOR CONTINUATION SEE DWG W7-07




PLAN VIEW

SCALE: 1"=20'-0"

0 20' 40'

A horizontal scale bar with alternating black and white segments. It is marked with '0' at the left end, '20'' at the midpoint, and '40'' at the right end.

FOR CONTINUATION SEE DWG W8-08




**COMMONWEALTH
ENGINEERS, INC.**

A wealth of resources to make a common goal.

<https://commonwealthengineers.com/>

OFFICE LOCATIONS IN:

- INDIANAPOLIS, IN. (2)
- EVANSVILLE, IN.
- FORT WAYNE, IN.
- CROWN POINT, IN.
- BOWLING GREEN, KY.
- SOUTH BEND, IN.



ALBERT C. STONG
REGISTERED
No. 10201336
STATE OF INDIANA
PROFESSIONAL ENGINEER

Albert C. Stong

Signature _____

Date 4/01/2025

**CITY OF ROCHESTER
FULTON COUNTY, INDIANA
LEAD SERVICE LINE
REPLACEMENT PROJECT - DAC
AREA**

© 2023 BY COMMONWEALTH ENGINEERS, INC. ALL RIGHTS RESERVED. REPRODUCTION BY ANY METHOD IN WHOLE OR IN PART WITHOUT PERMISSION IS PROHIBITED

Indiana 811

Know what's below. 811 before you dig.

1-800-382-5544
(ITS THE LAW)

[illegible]

Designed By: AL	Drawn By: SSE	Checked By: RAL
Issue Date: SUBMITTAL	Project No: W24156	Scale: AS SHOWN

PLAN VIEW

Drawing No:

W8-07

Sheet: 82 OF 86


FOR CONTINUATION SEE DWG W8-07

FOR CONTINUATION SEE DWG W7-08



PLAN VIEW

SCALE: 1"=20'-0"

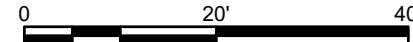


PROPOSED PLAN NOTES:

- ① CONTRACTOR SHALL VERIFY THE EXISTING SERVICE LINE MATERIAL TO BE EITHER LEAD OR GALVANIZED PRIOR TO REPLACING THE SERVICE LINE. CONTRACTOR SHALL POTHOLE THE CITY-OWNED SIDE OF THE SERVICE LINE A MINIMUM OF 3 FT BACK FROM CURB STOP.
- ② NEW 1" WATER SERVICE AND CURB STOP OR METER PIT
- ③ NEW 1-1/2" WATER SERVICE AND CURB STOP OR METER PIT
- ④ CURB STOP AND/OR METER PIT IS SHOWN FOR REPLACEMENT AND COULD NOT BE LOCATED IN THE FIELD. CONTRACTOR SHALL LOCATE PRIOR TO REPLACEMENT.
- ⑤ CONTRACTOR SHALL DISCONNECT EXISTING SERVICE LINE AT WATER MAIN AND ABANDON. EXISTING SERVICE LINE SHALL BE CUT AND CRIMPED. SERVICE LINE SHALL NOT BE REPLACED SINCE LOT IS EMPTY.



COMMONWEALTHTM
ENGINEERS, INC.
A wealth of resources to master a common goal.



ALBERT C. STONG
REGISTERED
No.
10201336
STATE OF
INDIANA
PROFESSIONAL ENGINEER

Albert C. Stong
Signature

4/01/2014
Date

**CITY OF ROCHESTER
FULTON COUNTY, INDIANA
LEAD SERVICE LINE
REPLACEMENT PROJECT - DAC
AREA**

© 2023 BY COMMONWEALTH ENGINEERS, INC. ALL RIGHTS RESERVED. REPRODUCTION BY ANY METHOD IN WHOLE OR IN PART WITHOUT PERMISSION IS PROHIBITED

Indiana 811

Know what's below. 811 before you dig.
1-800-382-5544
(ITS THE LAW)

[illegible]



Designed By: AL	Drawn By: SSE	Checked By: RAL
Issue Date: SUBMITTAL	Project No: W24156	Scale: AS SHOWN

LAN VIEW



Drawing No:

V8-08

Sheet: 83 OF 86

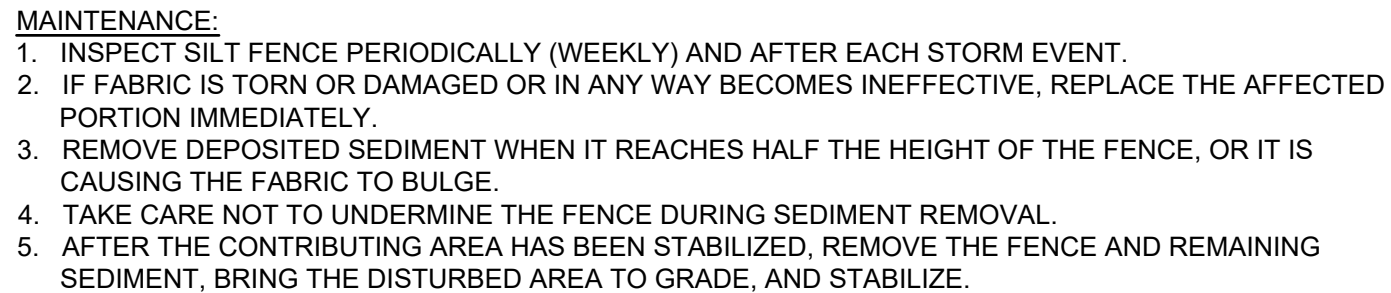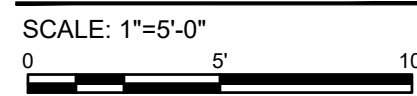

- SCALE: 1"=5'-0"
-
- A horizontal graphic scale bar with alternating black and white segments. It is marked with '0' at the left end, '5'' at the midpoint, and '10'' at the right end.

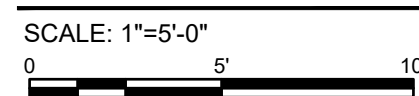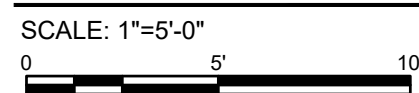

- AT SLOPE LENGTHS GREATER THAN 300 FEET OR WHERE DRAINAGE OVER LARGE AREAS IS DIRECTED ONTO THE BLANKETS, STAPLE PATTERN "C" SHOULD BE UTILIZED.